

OWNER: DAVIS, RYAN & CUSSIMANO, REAGAN
ADDRESS: 17181 W. 159TH ST.
UNPLATTED

OWNER: DAVIS, RYAN & CUSSIMANO, REAGAN
ADDRESS: 17181 W. 159TH ST.
UNPLATTED

OWNER: STEVE A. DAVIS & JAMES H. DAVIS TRUST
ADDRESS: 16055 APACHE ST.
UNPLATTED

OWNER: GLASGOW, JIM J. & SHELLY
ADDRESS: 17020 W. 161ST ST.

OWNER: CORTIS H. SMC III
ADDRESS: 16980 W. RETIST ST.

OWNER: BRADLEY & REBECCA
ADDRESS: 16900 W. 161ST ST.

OWNER: BURROWS, MICHAEL L. & KATHERINE A.
ADDRESS: 16940 W. 161ST ST.

OWNER: CHRISTOPHER WAYNE
ADDRESS: 16920 W. 161ST ST.

LOT 1 OLATHE FIRE STATION NO. 7
OWNER: CITY OF OLATHE
ADDRESS: 16110 S. MUR-LEN
(SITE ADDRESS)


LOT 1 159TH & MUR-LEN PRICE CHOPPER CENTER
OWNER: PC LLC
ADDRESS: 17181 W. 159TH ST.
(SITE ADDRESS)

ARBOR CREEK VILLAGE, 12TH PLAT
OWNER: MURLIN 159 LLC
ADDRESS: 15970 S. BRADLEY DR.

OWNER: BOOTH, NATALIYA
ADDRESS: 16114 S. BRADLEY DR.

OWNER: BODENMILLER FAMILY TRUST
ADDRESS: 16126 S. BRADLEY DR.

OWNER: MERCER, IRONDA E. & JON
ADDRESS: 16158 S. BRADLEY DR.

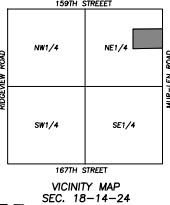

PHASE I
PHASE II



UTILITY NOTES:
VISUAL INDICATIONS OF UTILITIES ARE AS SHOWN.
UNDERGROUND LOCATIONS SHOWN AS FURNISHED BY THEIR LESSORS, ARE APPROXIMATE AND SHOULD BE VERIFIED IN THE FIELD AT THE TIME OF CONSTRUCTION. FOR ACTUAL FIELD LOCATIONS OF UNDERGROUND UTILITIES CALL 811.


PHASING PLAN
HOM FLATS AT MUR-LEN ROAD
OLATHE, KANSAS
PRELIMINARY PLANS

PHASE ENGINEERING INC.
1000 N. Webster
Olathe, Kansas 66041
Tel: 781-888-8888
www.phaseeng.com



By	Date	Revised
JMD	11/14/24	REVISED PER CITY COMMENTS
JMD	11/14/24	REVISED PER CITY COMMENTS
JMD	11/14/24	REVISED PER CITY COMMENTS
JMD	11/14/24	ADDED PATOS

SHEET
C1.2


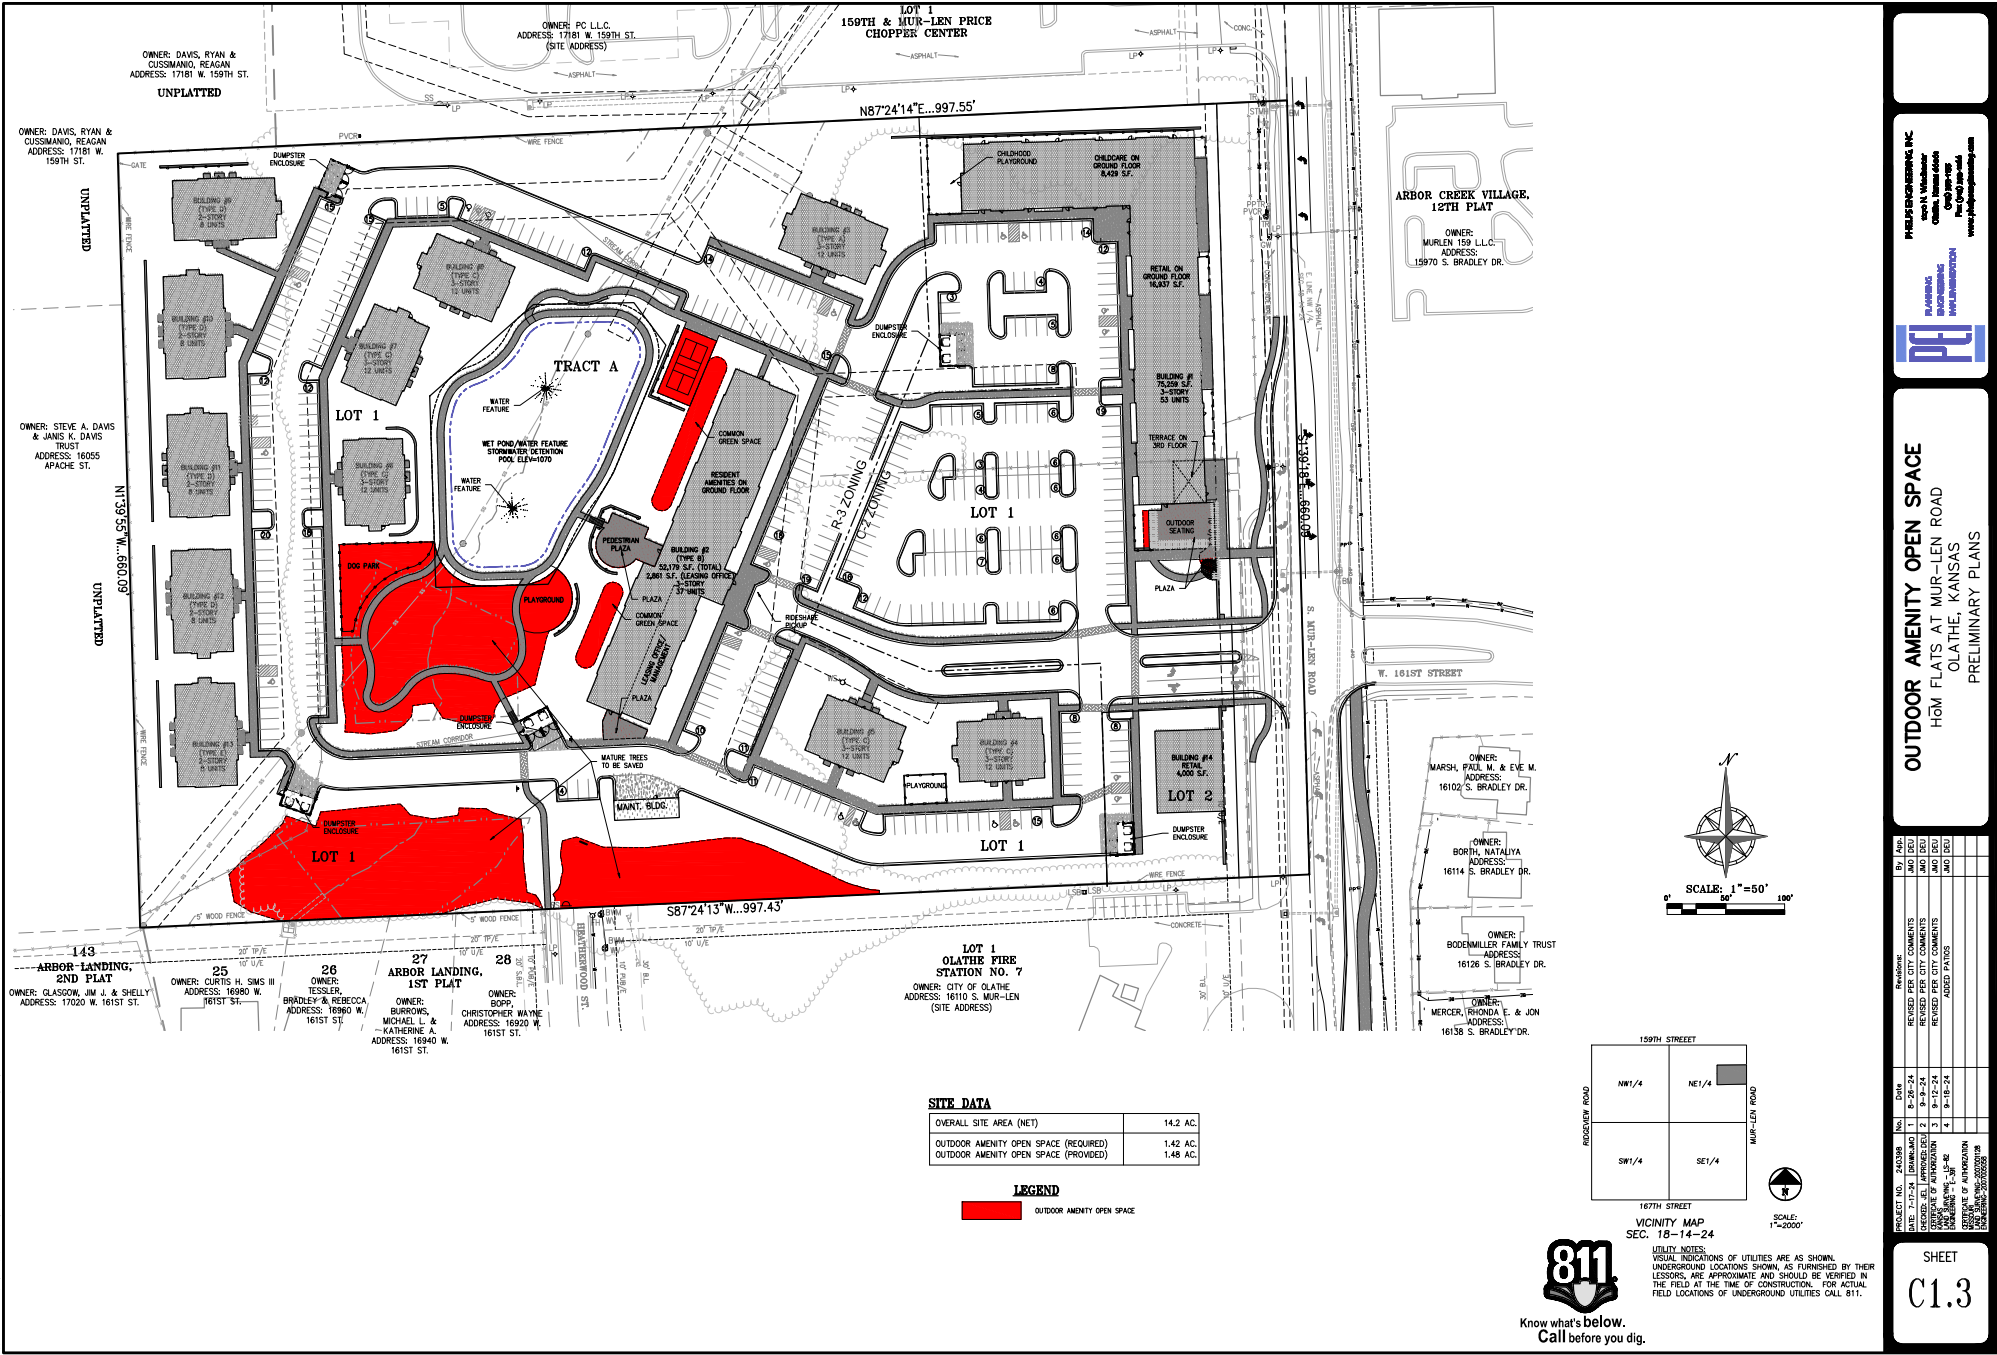


SITE DATA

OVERALL SITE AREA (NET)	14.2 AC.
OUTDOOR AMENITY OPEN SPACE (REQUIRED)	1.42 AC.
OUTDOOR AMENITY OPEN SPACE (PROVIDED)	1.46 AC.

LEGEND

OUTDOOR AMENITY OPEN SPACE

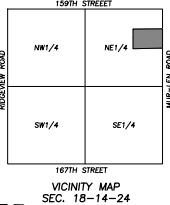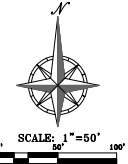

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PRELIMINARY PLANS

PROJECT NO. 240398
 DATE 11/14/24
 DRAWN BY JMD
 CHECKED BY JMD
 REVISIONS PER CITY COMMENTS
 REVISIONS PER CITY COMMENTS
 REVISIONS PER CITY COMMENTS
 ADDED PATIOS



OUTDOOR AMENITY OPEN SPACE
 160M FLATS AT MUR-LEN ROAD
 OLATHE, KANSAS
 PRELIMINARY PLANS

OWNER: MARSH, PAUL M. & EVE M.
 ADDRESS: 16102 S. BRADLEY DR.

OWNER: BOOTH, NATALIYA
 ADDRESS: 16114 S. BRADLEY DR.


OWNER: BODENMILLER FAMILY TRUST
 ADDRESS: 16126 S. BRADLEY DR.

OWNER: MERCER, IRONDA E. & JON
 ADDRESS: 16138 S. BRADLEY DR.

PROJECT NO.	240398
DATE	11/14/24
DRAWN BY	JMD
CHECKED BY	JMD
REVISIONS PER CITY COMMENTS	
REVISIONS PER CITY COMMENTS	
REVISIONS PER CITY COMMENTS	
ADDED PATIOS	



SHEET
C1.3

JMD/PS - CIVIL ENGINEER (P) 240398 (11/14/24) PRELIMINARY/GENERAL OPEN SPACE.dwg User: jmd Date: 11/14/24 3:11pm E:\PROJECTS\240398\DWG\240398-01.dwg

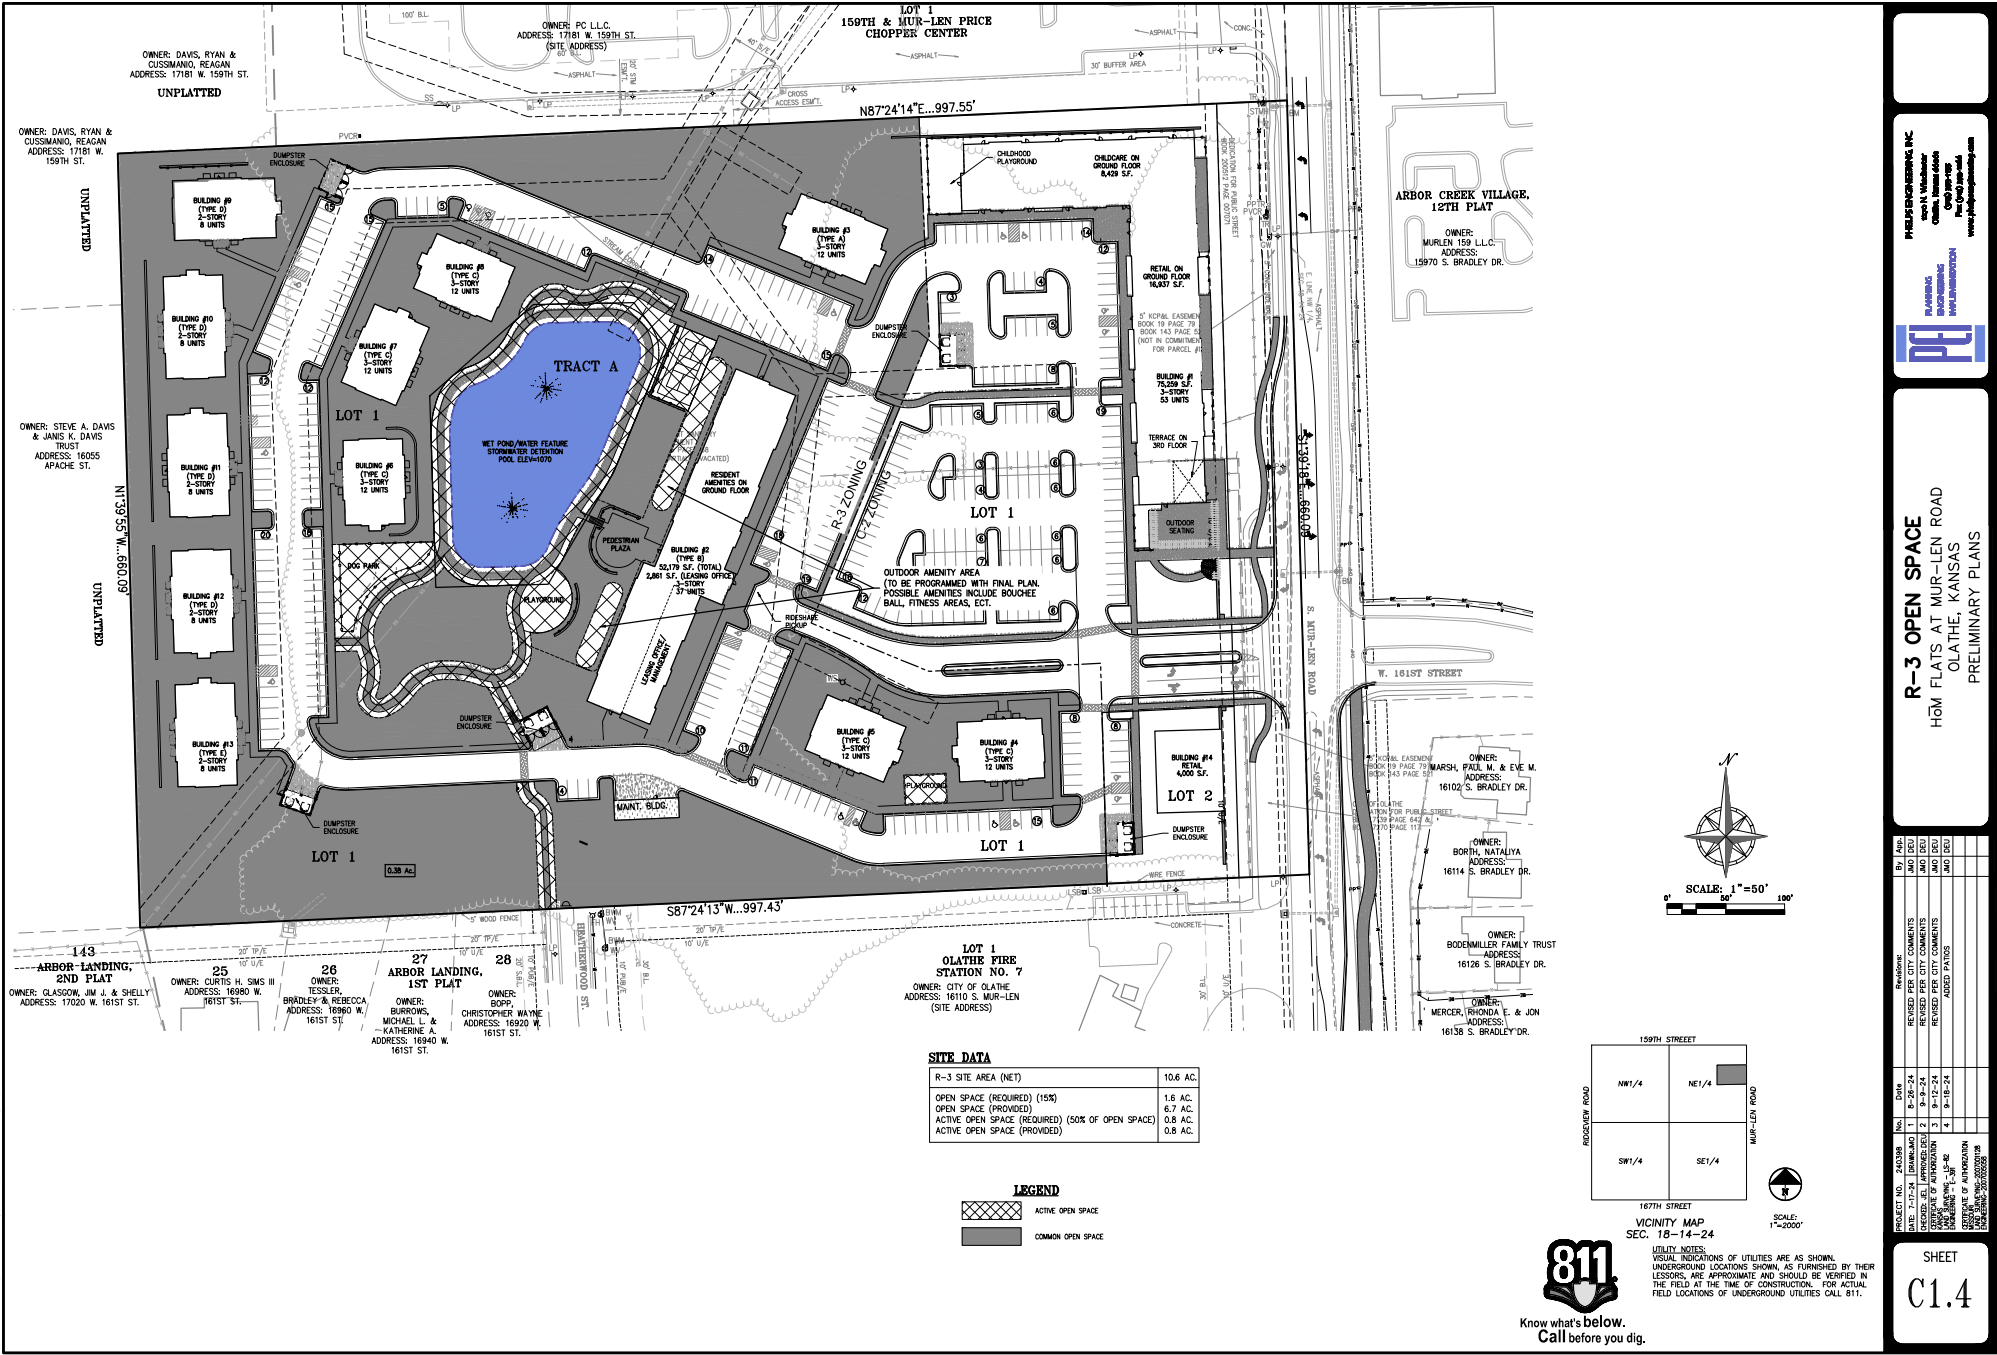

SITE DATA

R-3 SITE AREA (NET)	10.6 AC.
OPEN SPACE (REQUIRED) (15%)	1.6 AC.
OPEN SPACE (PROVIDED)	6.7 AC.
ACTIVE OPEN SPACE (REQUIRED) (50% OF OPEN SPACE)	0.8 AC.
ACTIVE OPEN SPACE (PROVIDED)	0.8 AC.

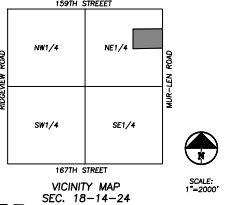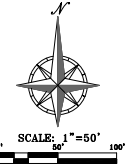

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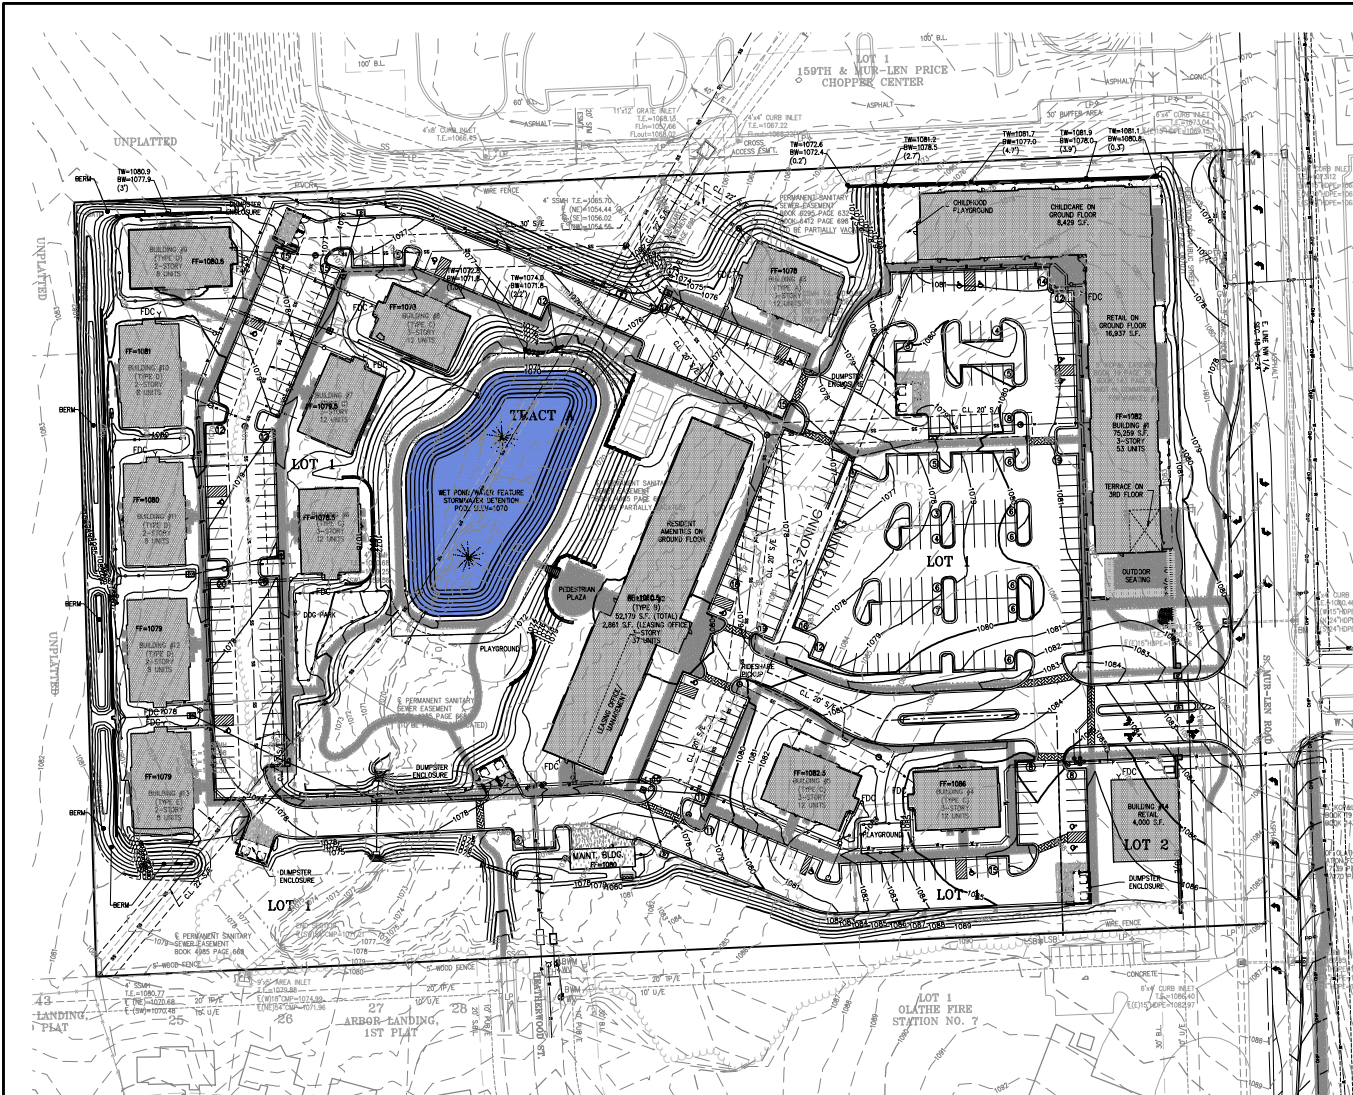
PRELIM ENGINEERING INC.
 Steve A. Winkler
 Owner, Design Author
 1615 S. Bradley Dr.
 Olathe, KS 66045
 www.prelimeng.com



R-3 OPEN SPACE
 160M FLATS AT MUR-LEN ROAD
 OLATHE, KANSAS
 PRELIMINARY PLANS

By	Date	Revisions
AND DEU	11/11/24	REVISED PER CITY COMMENTS
AND DEU	11/12/24	REVISED PER CITY COMMENTS
AND DEU	11/12/24	REVISED PER CITY COMMENTS
AND DEU	11/12/24	ADDED PATOS

SHEET
C1.4



SITE GRADING NOTES:


- CONTOURS AND ELEVATIONS:** Existing and proposed contours are shown on plans at one foot (1') contour intervals, unless otherwise noted. Proposed contours and elevations show representative finish grade. Contractor shall hold down subgrade to allow for pavement and sub-base thickness.
 - If the contractor does not accept existing topography as shown on the plans, unless otherwise noted, he shall have made of his expense a topographic survey by a registered land surveyor and submit it to the owner for review.
 - CLEARING AND GRUBBING:** Prior to beginning preparation of subgrade, all areas under pavements or buildings shall be stripped of all topsoil, vegetation, large rock fragments (greater than 6 inches in any dimension) and any other deleterious material. The actual stripping depth should be based on visual inspection during construction and the results of proof-rolling operations. The root systems of all trees (not designated to remain) shall be removed in their entirety. Stripping materials shall not be incorporated into structural fill.
 - TOPSOIL STRIPPING:** Prior to the start of site grading, the contractor shall strip all topsoil from areas to be graded, and stockpiled at a location on or adjacent to the site as directed by the owner. At completion of grading operations and related construction, the contractor shall be responsible for redistribution of topsoil over all areas disturbed by the construction activities. Topsoil shall be placed to a minimum depth of six inches (6") and in accordance with specifications for landscaping. At that time, and prior to the installation of landscaping or irrigation, all liquid grades areas shall be visually inspected and accepted by the owner and ILL.
 - Contractor shall adjust and/or cut existing pavement in necessary to ensure a smooth fit and continuous grade. Contractor shall ensure positive drainage away from buildings for all natural and proposed drainage.
 - SUBGRADE PREPARATION:** Prior to placement of new fill materials, the existing subgrade shall be provided and approved under the direction of the Geotechnical Engineer or his representative.
 - PROOF-ROLLING:** Subsequent to completion of stripping and over-excavation, of building and pavement areas to receive structural fill, all areas shall be systematically proof-rolled using a tandem axle dump truck loaded to approximately 6,000 pounds per axle. Areas, any finished subgrade areas to receive paving shall be proof-rolled within 48 hours of paving. Unstable soils that are detected and that can not be incorporated should be over-excavated and replaced with controlled structural fill.
- A) GEOTECHNICAL:** All earthwork shall conform to the recommendations of the Geotechnical report. Solid report and its recommendations are hereby incorporated into the project requirements by reference. Prior to beginning construction, the contractor shall obtain a copy of and become familiar with the geotechnical report. Unless specifically noted on the plans, the recommendations in the geotechnical report are hereby incorporated into the project requirements and specifications.
- C) FLOODS:** All fills shall be considered controlled or structural fill and shall be free of vegetation, organic matter, topsoil and debris, in areas where the thickness of the engineered fill is greater than five feet. All building and pavement construction shall not commence until so authorized by the on-site geotechnical engineer to allow for consolidation.
- D) BUILDING SUBGRADE:** As specified in the Geotechnical Engineering Report, the upper section of building subgrade shall consist of Low Volume Drains (LVD) material defined as approved compacted granular fill or less to maintain practically compacted soil materials stabilized with Class C Flyash. Granular fill shall consist of compacted granular materials with a maximum particle size of two (2) inches or less, such as crushed screenings. Refer to geotechnical report for compaction requirements.
- E) EXISTING SLOPES:** Where fill material is to be placed on existing slopes greater than 5:1 (horizontal to vertical), existing slope shall be bench graded to a minimum vertical face of twelve (12) feet. The benches shall be cut wide enough to accommodate the compaction equipment. Fill material shall be placed and compacted in horizontal lifts not exceeding nine (9) inches (9" loose fill measurement), unless otherwise approved by the Geotechnical Engineer.
- F) COMPACTION REQUIREMENTS:** The upper 8 inches of pavement subgrade areas shall be compacted to a minimum density of ninety five percent (95%) of the material's maximum dry density as determined by ASTM D698 (Standard Proctor compaction). The moisture content at the time of placement and compaction shall be within a range of 0.5% below to 4% above optimum moisture content as defined by the standard proctor procedure. The moisture contents shall be maintained within this range until completion of the earth. Where compaction of earth fill is a large area or impractical or undesirable, the earth fill shall be hand compacted with small vibrating rollers or mechanical tampers.
- All cut or fill slopes shall be 3:1 or flatter. All asphalt parking areas shall be a minimum of 18" stone but not more than 5% slope unless otherwise noted. All pavements within 400 parking spaces shall not exceed 2% total slope. All grades around buildings shall be held down 4" from finish floor and slope away a minimum of 1/8" in 10 feet. Contractor shall notify engineer prior to final subgrade construction of any area not within this slope requirement.
 - TESTING AND INSPECTION:** Owner's Independent Testing Laboratory (ITL) shall make tests of earthwork during construction and observe the placement of fills and other work performed on this project to verify that work has been completed in accordance with Geotechnical Engineering Report, Project Specifications and other industry standards. The ITL will be selected by the owner and the cost of testing will be the owner's responsibility.
 - CLASSIFICATION:** All excavation shall be considered unclassified. No separate or additional payments shall be made for rock excavation.
 - PERMANENT RESTORATION:** All areas disturbed by earthwork operations shall be seeded, unless shown otherwise by the landscaping plan or erosion control plan.
 - UTILITIES:** The contractor is specifically cautioned that the location and/or elevation of existing utilities as shown on these plans is based on records of the various utility companies, and when possible, measurements taken in the field. This information is not to be relied on as being exact or complete. The contractor must call the appropriate utility companies at least 48 hours before any excavation to report exact field location of utilities. If it is necessary for the contractor to relocate any existing utilities which conflict with the proposed improvements shown on the plans.
 - LAND DISTURBANCE:** The contractor shall adhere to all terms & conditions as outlined in the EPA or applicable state N.P.D.S. permit for storm water discharge associated with construction activities. Refer to project SWPPP requirements.

ADA PATH NOTE:

THE CONTRACTOR SHALL BE RESPONSIBLE THAT THE SIDEWALK/CROSSWALK SHALL NOT EXCEED 2% CROSS SLOPE OR 5% RUNNING SLOPE (IN THE DIRECTION OF TRAVEL, EXCEPT AT RAMP LOCATIONS).

LEGEND

- PL — PROPERTY LINE
- LOT LINE —
- R/W — RIGHT-OF-WAY
- 2' CURB & GUTTER —
- 200 — EXISTING CONTOURS
- 200 — PROPOSED CONTOURS
- 200 — PROPOSED SPOT ELEVATION
- LG — UP OF CUTTER
- LE — TOP OF CURB
- SW — SIDEWALK
- ME — MATCH EXISTING
- HP — HIGH POINT
- LP — LOW POINT
- P — TOP OF PAVEMENT
- TS — TOP OF STRUCTURE
- OK — GROUND ELEVATION
- BS — BOTTOM OF STEPS
- TS — TOP OF STEPS
- BT — BOTTOM OF WALL
- TW — TOP OF WALL
- — — — — EXISTING STORM SEWER
- — — — — PROPOSED STORM PIPE
- — — — — PROPOSED WET CURB & GUTTER
- — — — — PROPOSED DRY CURB & GUTTER
- — — — — PROPOSED RETAINING WALL

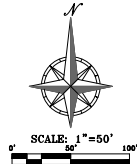


FLOOD NOTE:

PARCEL 1: THIS PROPERTY LIES WITHIN ZONE X, DEFINED AS AREAS DETERMINED TO BE OUTSIDE THE 0.2% ANNUAL CHANCE FLOODPLAIN, AS SHOWN ON THE FLOOD INSURANCE RATE MAP PREPARED BY THE FEDERAL EMERGENCY MANAGEMENT AGENCY FOR THE CITY OF OLAH, COUNTY NO. 200773, JOHNSON COUNTY, KANSAS, MAP NO. 200610100, AND DATED AUGUST 3, 2006.

PARCEL 2: THIS PROPERTY LIES WITHIN ZONE X, DEFINED AS AREAS DETERMINED TO BE OUTSIDE THE 0.2% ANNUAL CHANCE FLOODPLAIN, AS SHOWN ON THE FLOOD INSURANCE RATE MAP PREPARED BY THE FEDERAL EMERGENCY MANAGEMENT AGENCY FOR JOHNSON COUNTY, COMMUNITY NO. 2001050, JOHNSON COUNTY, KANSAS, MAP NO. 200610100, AND DATED AUGUST 3, 2006.

BENCHMARK:

VERTICAL DATUM = NAVD83 BASED ON GPS OBSERVATION
 1. SET 7' COT IN CENTER FRONT FACE OF CURB INLET AT NORTHEAST CORNER OF PROPERTY
 ELEVATION = 1070.94

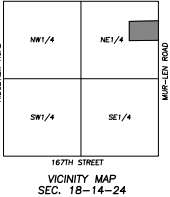

PHILIPS ENGINEERING, INC.
 2001 W. WOODWARD
 CHINA, MISSOURI 64601
 (417) 435-1100
 www.philipsengineering.com



GRADING PLAN
 H&M FLATS AT MUR-LEN ROAD
 OLAH, KANSAS
 PRELIMINARY PLANS

PROJECT NO.	DATE	BY	CHKD.	REVISED
243088	08/14/24	AM	AM	1
		AM	AM	2
		AM	AM	3
		AM	AM	4



SHEET
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V:\P\PS-GEN\Projects\243088\1\preliminary\grading\grading.dwg 10/24/24 10:31am JAM/ET/DAI



811
 Know what's below.
 Call before you dig.

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SCALE: 1"=20' HORIZ.
1"=20' VERT.



PERFORMANCE INC.
124286
12/15/2024

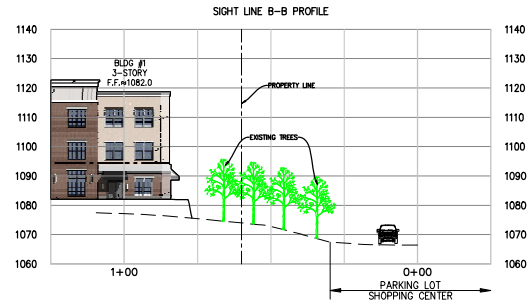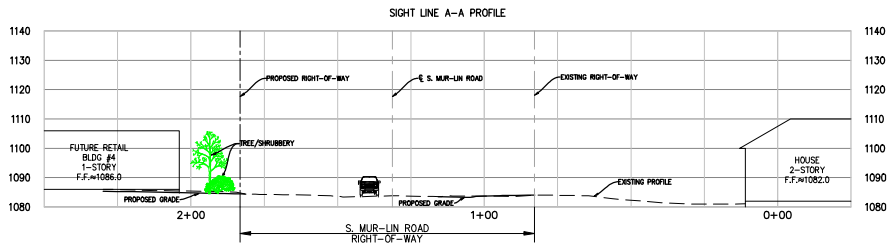

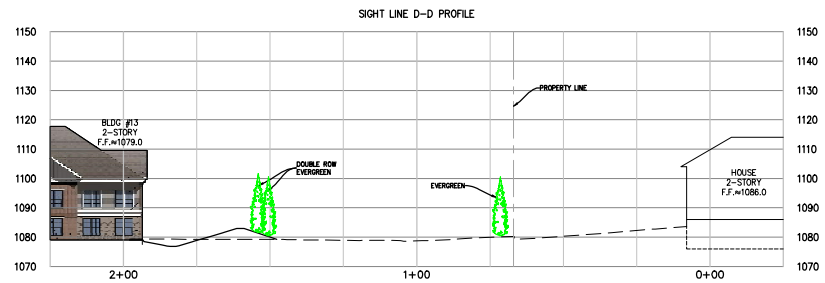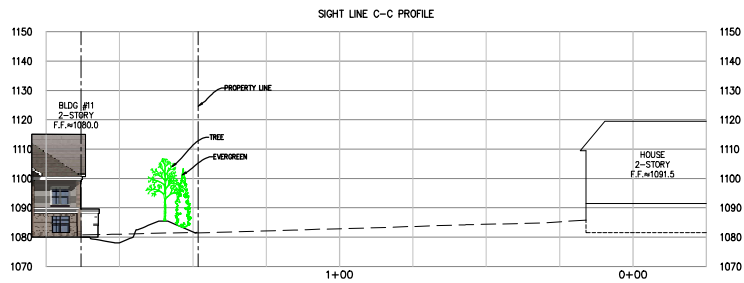LINE OF SIGHT SECTION VIEWS
HOM FLATS AT MUR-LIN ROAD
OLA THE, KANSAS
PRELIMINARY PLANS

PROJECT NO.	DATE	NO.	DESCRIPTION	BY	CHKD.
124286	12-15-24	1	ISSUED FOR PERMITS	JMD	DEU
		2	REVISED PER CITY COMMENTS	JMD	DEU
		3	REVISED PER CITY COMMENTS	JMD	DEU
		4	ADDED PLATOS	JMD	DEU

SHEET
C7.1

