




GENERAL NOTES


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- B. SIDING TO BE AUTHENTIC 3 COAT STUCCO SYSTEM. EXTEND STUCCO TO WITHIN 8" OF FINISHED GRADE. COLOR TO MATCH EXISTING BUILDING. PROVIDE STUCCO CONTROL JOINTS AS INDICATED.
- C. STONE TO BE 6" NATURAL STONE VENEER. COLOR TO MATCH EXISTING ATMOS BUILDING.
- D. FASCIA TO BE ROUGH SAUN CEDAR.
- E. OVERHEAD DOORS HAVE DARK BRONZE FRAMES WITH GLASS PANELS.

ELEVATION NOTES

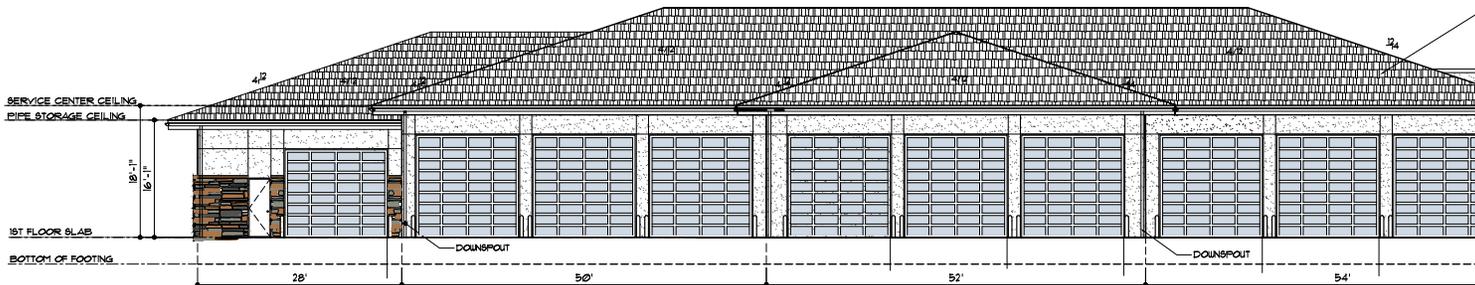

PARTIAL NORTH ELEVATION - SECONDARY FACADE

1/8" = 1'-0"

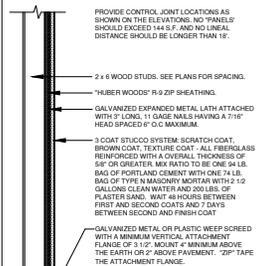


1 STUCCO DETAIL
3/4"x1"-0" A-DIV-09206-04

ATMOS ENERGY
MATERIAL USAGE - SQUARE FOOTAGE TABLE

NORTH ELEVATION - SECONDARY FACADE - W. 19TH TERR.

MATERIAL	AREA	PERCENT	
STUCCO - GENUINE	322	5.4%	
NATURAL STONE VENEER	444	7%	100
TRANSPARENT GLASS	2332	37.6%	
TOTAL MATERIAL AREA	2998	100%	100%

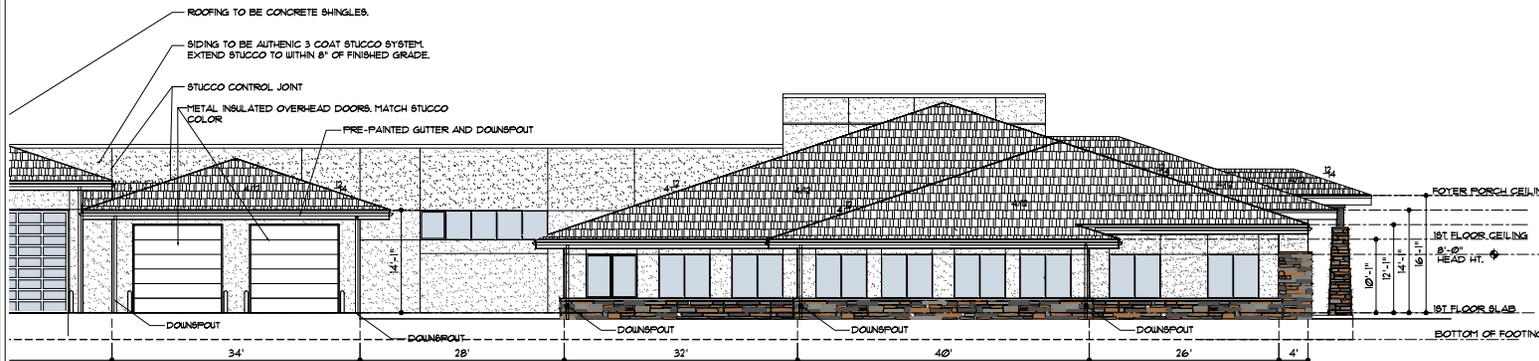

PARTIAL NORTH ELEVATION - SECONDARY FACADE

1/8" = 1'-0"

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ATMOS ENERGY CORPORATION
CEDAR CREEK CORPORATE PARK
110TH AND SOUTH GREEN ROAD
OLA THe, KANSAS 66061

CEDAR CREEK DEVELOPMENT VIII, L.L.C.
800 EAST 101ST TERRACE, SUITE 120
KANAS CITY, MISSOURI 64131

DRAWN BY: MP, DW, KF
DATE: 9-24-24
REVISION DATE:
PROJECT NO: 24-012-01

SHEET NO
A5.2

GENERAL NOTES

- A. ROOFING TO BE CONCRETE SHINGLES. COLOR TO MATCH EXISTING ATMOS BUILDING.
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EXTERIOR COLORS



- 1. STONE VENEER
COLOR: BROWN-BEIGE-TAN
- 2. CAST STONE CAP
BROWN
- 3. ROOFING
CONCRETE SHINGLES;
LIGHT BROWN
- 4. OVERHEAD DOORS
DARK BRONZE FRAMES
WITH GLASS PANELS
WINDOW FRAMES
- 5. SIDING
STUCCO : CLAY

ATMOS ENERGY


MATERIAL USAGE - SQUARE FOOTAGE TABLE

WEST ELEVATION - PRIMARY FACADE - S. GREEN RD.


MATERIAL	AREA	PERCENT	
STUCCO - GENUINE	1052	46%	
NATURAL STONE VENEER	994	26%	100%
TRANSPARENT GLASS	644	28%	
TOTAL MATERIAL AREA	2290	100%	100%

EAST ELEVATION - SECONDARY FACADE - SHADY BEND RD.

MATERIAL	AREA	PERCENT	
STUCCO - GENUINE	1044	50%	
NATURAL STONE VENEER	652	31%	100%
TRANSPARENT GLASS	402	19%	
TOTAL MATERIAL AREA	2098	100%	100%

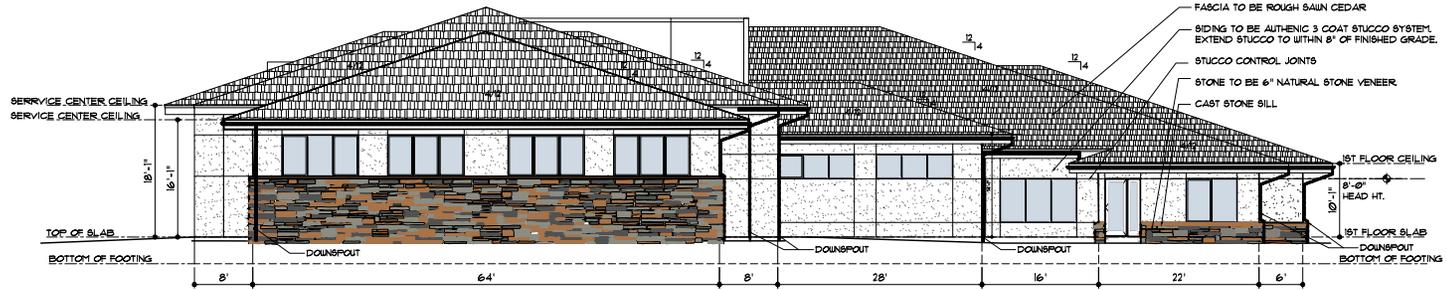

EAST ELEVATION - SECONDARY FACADE
1/8" = 1'-0"

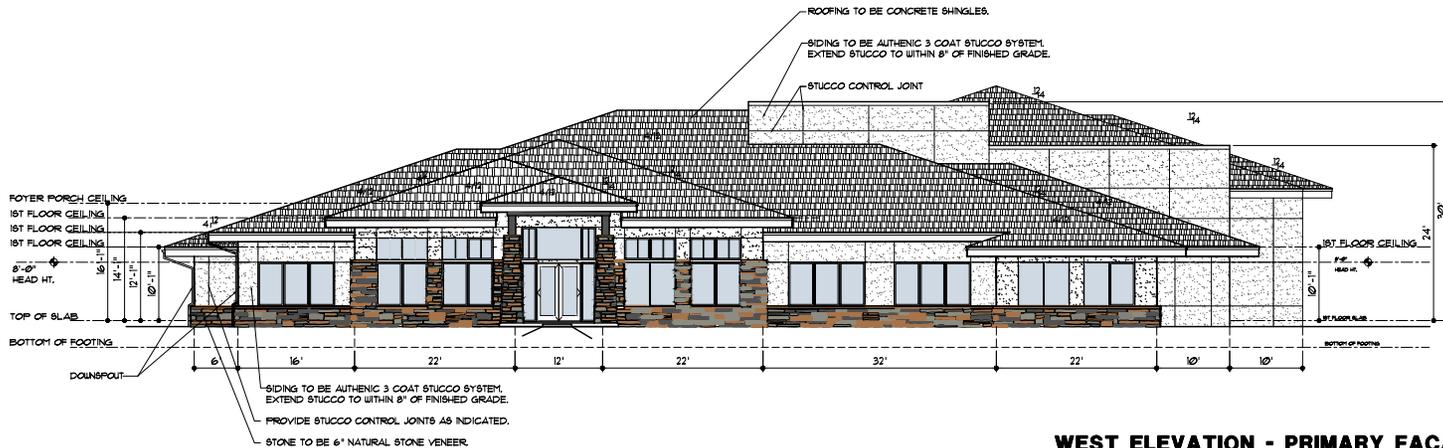

WEST ELEVATION - PRIMARY FACADE
1/8" = 1'-0"

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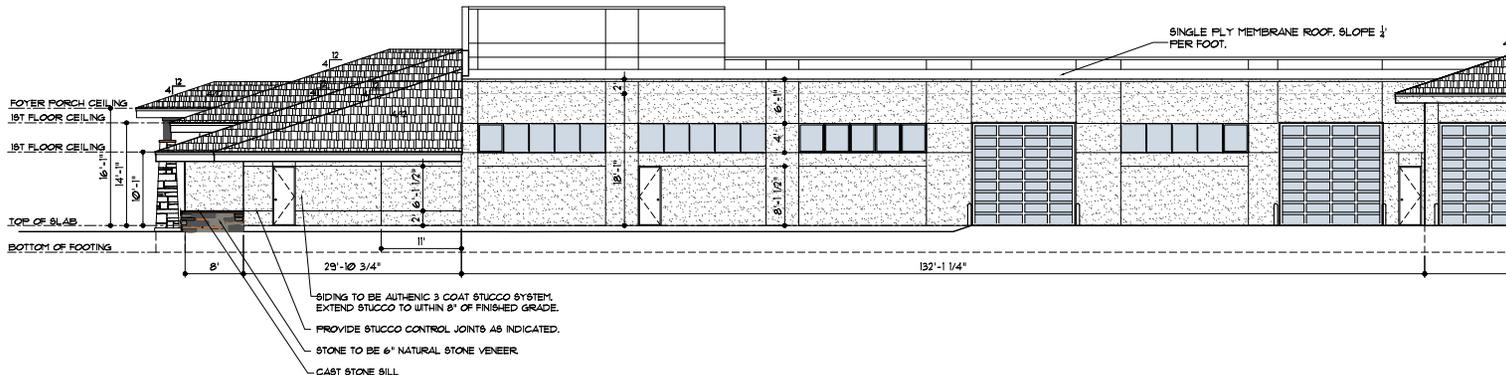
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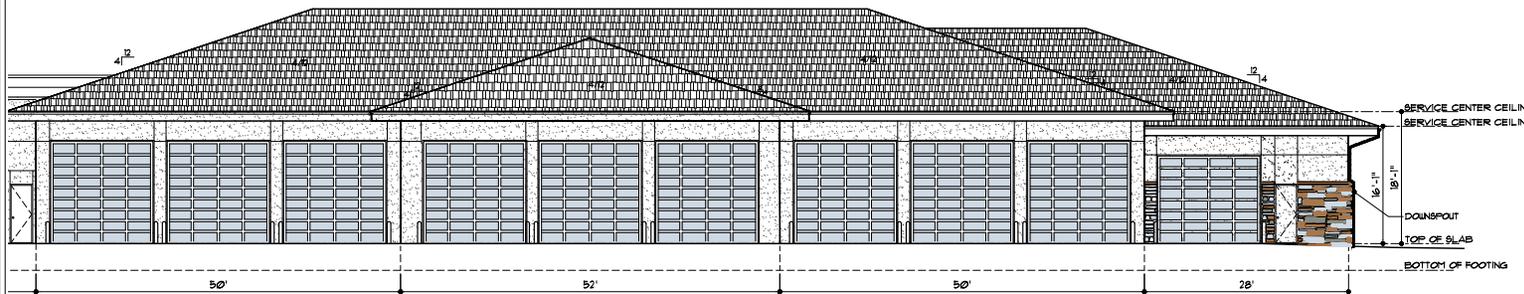
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PARTIAL SOUTH ELEVATION - SECONDARY FACADE

1/4" = 1'-0"



PARTIAL SOUTH ELEVATION - SECONDARY FACADE

1/4" = 1'-0"

ATMOS ENERGY
MATERIAL USAGE - SQUARE FOOTAGE TABLE

SOUTH ELEVATION - SECONDARY FACADE

MATERIAL	AREA	PERCENT	
STUCCO - GENUINE	3351	54%	
NATURAL STONE VENEER	76	2%	100%
TRANSPARENT GLASS	2152	44%	
TOTAL MATERIAL AREA	6279	100%	100%

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SHEET NO.
A5.3