SITE DATA: CURRENT ZONING: R-3 CURRENT ZONING: R-3 PROPOSED ZONING: R-4 SITE DESIGN CATEGORY 3 BUILDING DESIGN CATEGORY B LANDSCAPE BUFFER TYPE 3 TOTAL OFEN SPACE: +-1 428,987 SQ FT COVERAGE: +1- 496,933

PARKING TABULATIONS:

GARAGE PARKING: PHASE 2: A - BUILDING 3 PHASE 3: B - BUILDING 3 PHASE 4: C - BUILDING 4 PHASE 5: 37 GARAGES 30 GARAGES 48 GARAGES PHASE 5: D - BUILDING 27 GARAGES 142 TOTAL

SURFACE PARKING 
 SUPFACE PARANCE

 PHASE 2
 21 SPACES (71 SPACES IN FUTURE)'

 PHASE 3
 21 SPACES (71 SPACES IN FUTURE)'

 PHASE 4
 SS SPACES

 PHASE 5
 SS SPACES

 900 TOTAL
 SS SPACE

PARKING REQUIRED: 1.5 x 444 UNITS = 666 SPACES

PARKING PROVIDED:

142 + 693 = 690 SPACES	
PHASE 2	37 GARAGES + 217 SURFACE = 254 (182 REQUIRED BY PHASE
	37 GARAGES + 210 SURFACE = 247 (182 REQUIRED BY PHASE
PHASE 3	30 GARAGES + 121 SURFACE = 151 (99 REQUIRED BY PHASE)
	30 GARAGES + 117 SURFACE = 147 (99 REQUIRED BY PHASE)
PHASE 4	48 GARAGES + 190 SURFACE = 238 (228 REQUIRED BY PHASE
PHASE 5	27 GARAGES + 165 SURFACE = 192 (158 REQUIRED BY PHASE
EXISTING CLUBHOUSE	14 SPACES ADDED (NOT INCLUDED IN TOTAL)

NOTE: PARKING SPACES BUILT AS PART OF PHASE 2 WILL BE SHARED BY PHASE 3 AFTER THE COMPLETION OF PHASE 3 CONSTRUCTION.

GROSS SITE AREA (ACRES) 18.98 DWELLING UNITS 444 GROSS SITE DENSITY (DUIAC) 23.39 GENERAL NOTES:

1. ALL MECHANICAL EQUIPMENT WILL BE SCREENED PER UDO REQUIREMENTS.



#### **REQUIRED:**

TOTAL SITE = 826,630 sq ft x 5% = 41,331 sq ft open space 41,331 SQ FT X 50% = 20,666 SQ FT ACTIVE OPEN SPACE


PROVIDED:

TOTAL OPEN SPACE - 329,697 SQ FT (39.9% OF TOTAL SITE)


ACTIVE OPEN SPACE - 174,721 SQ FT (53.0% OF TOTAL OPEN SPACE)


PASSIVE OPEN SPACE - 154,976 SQ FT (47.0% OF TOTAL OPEN SPACE)


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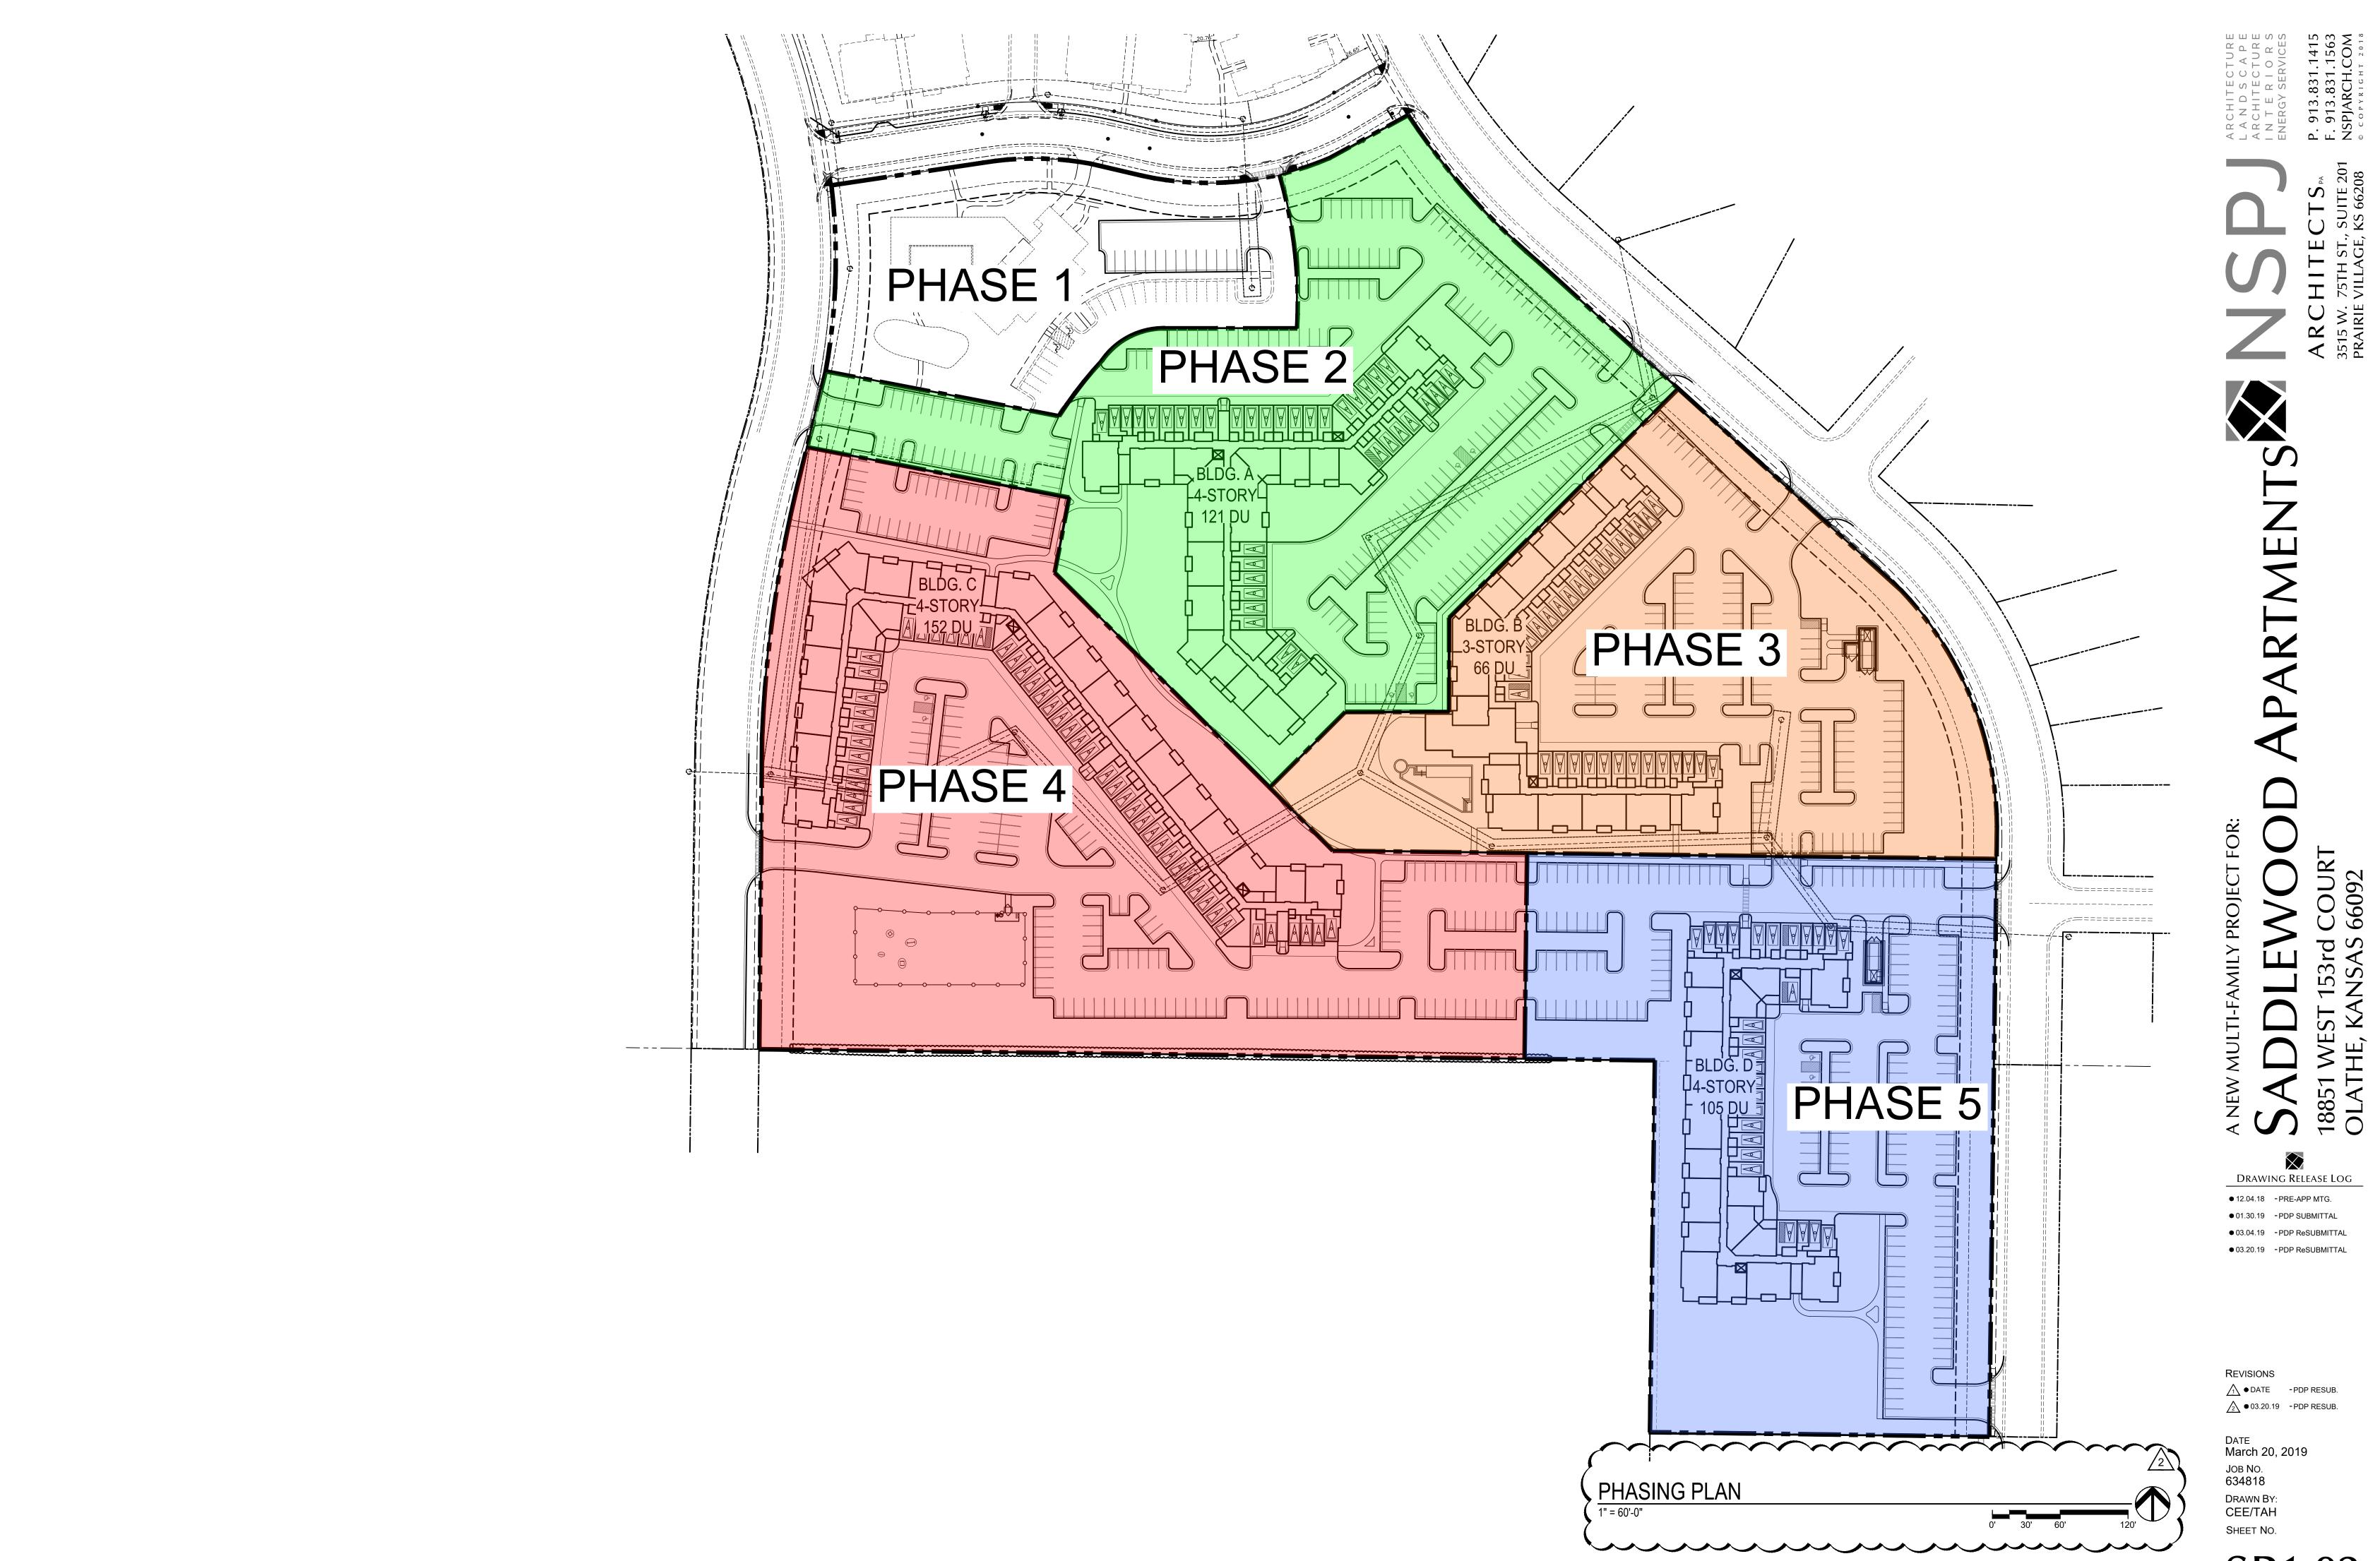


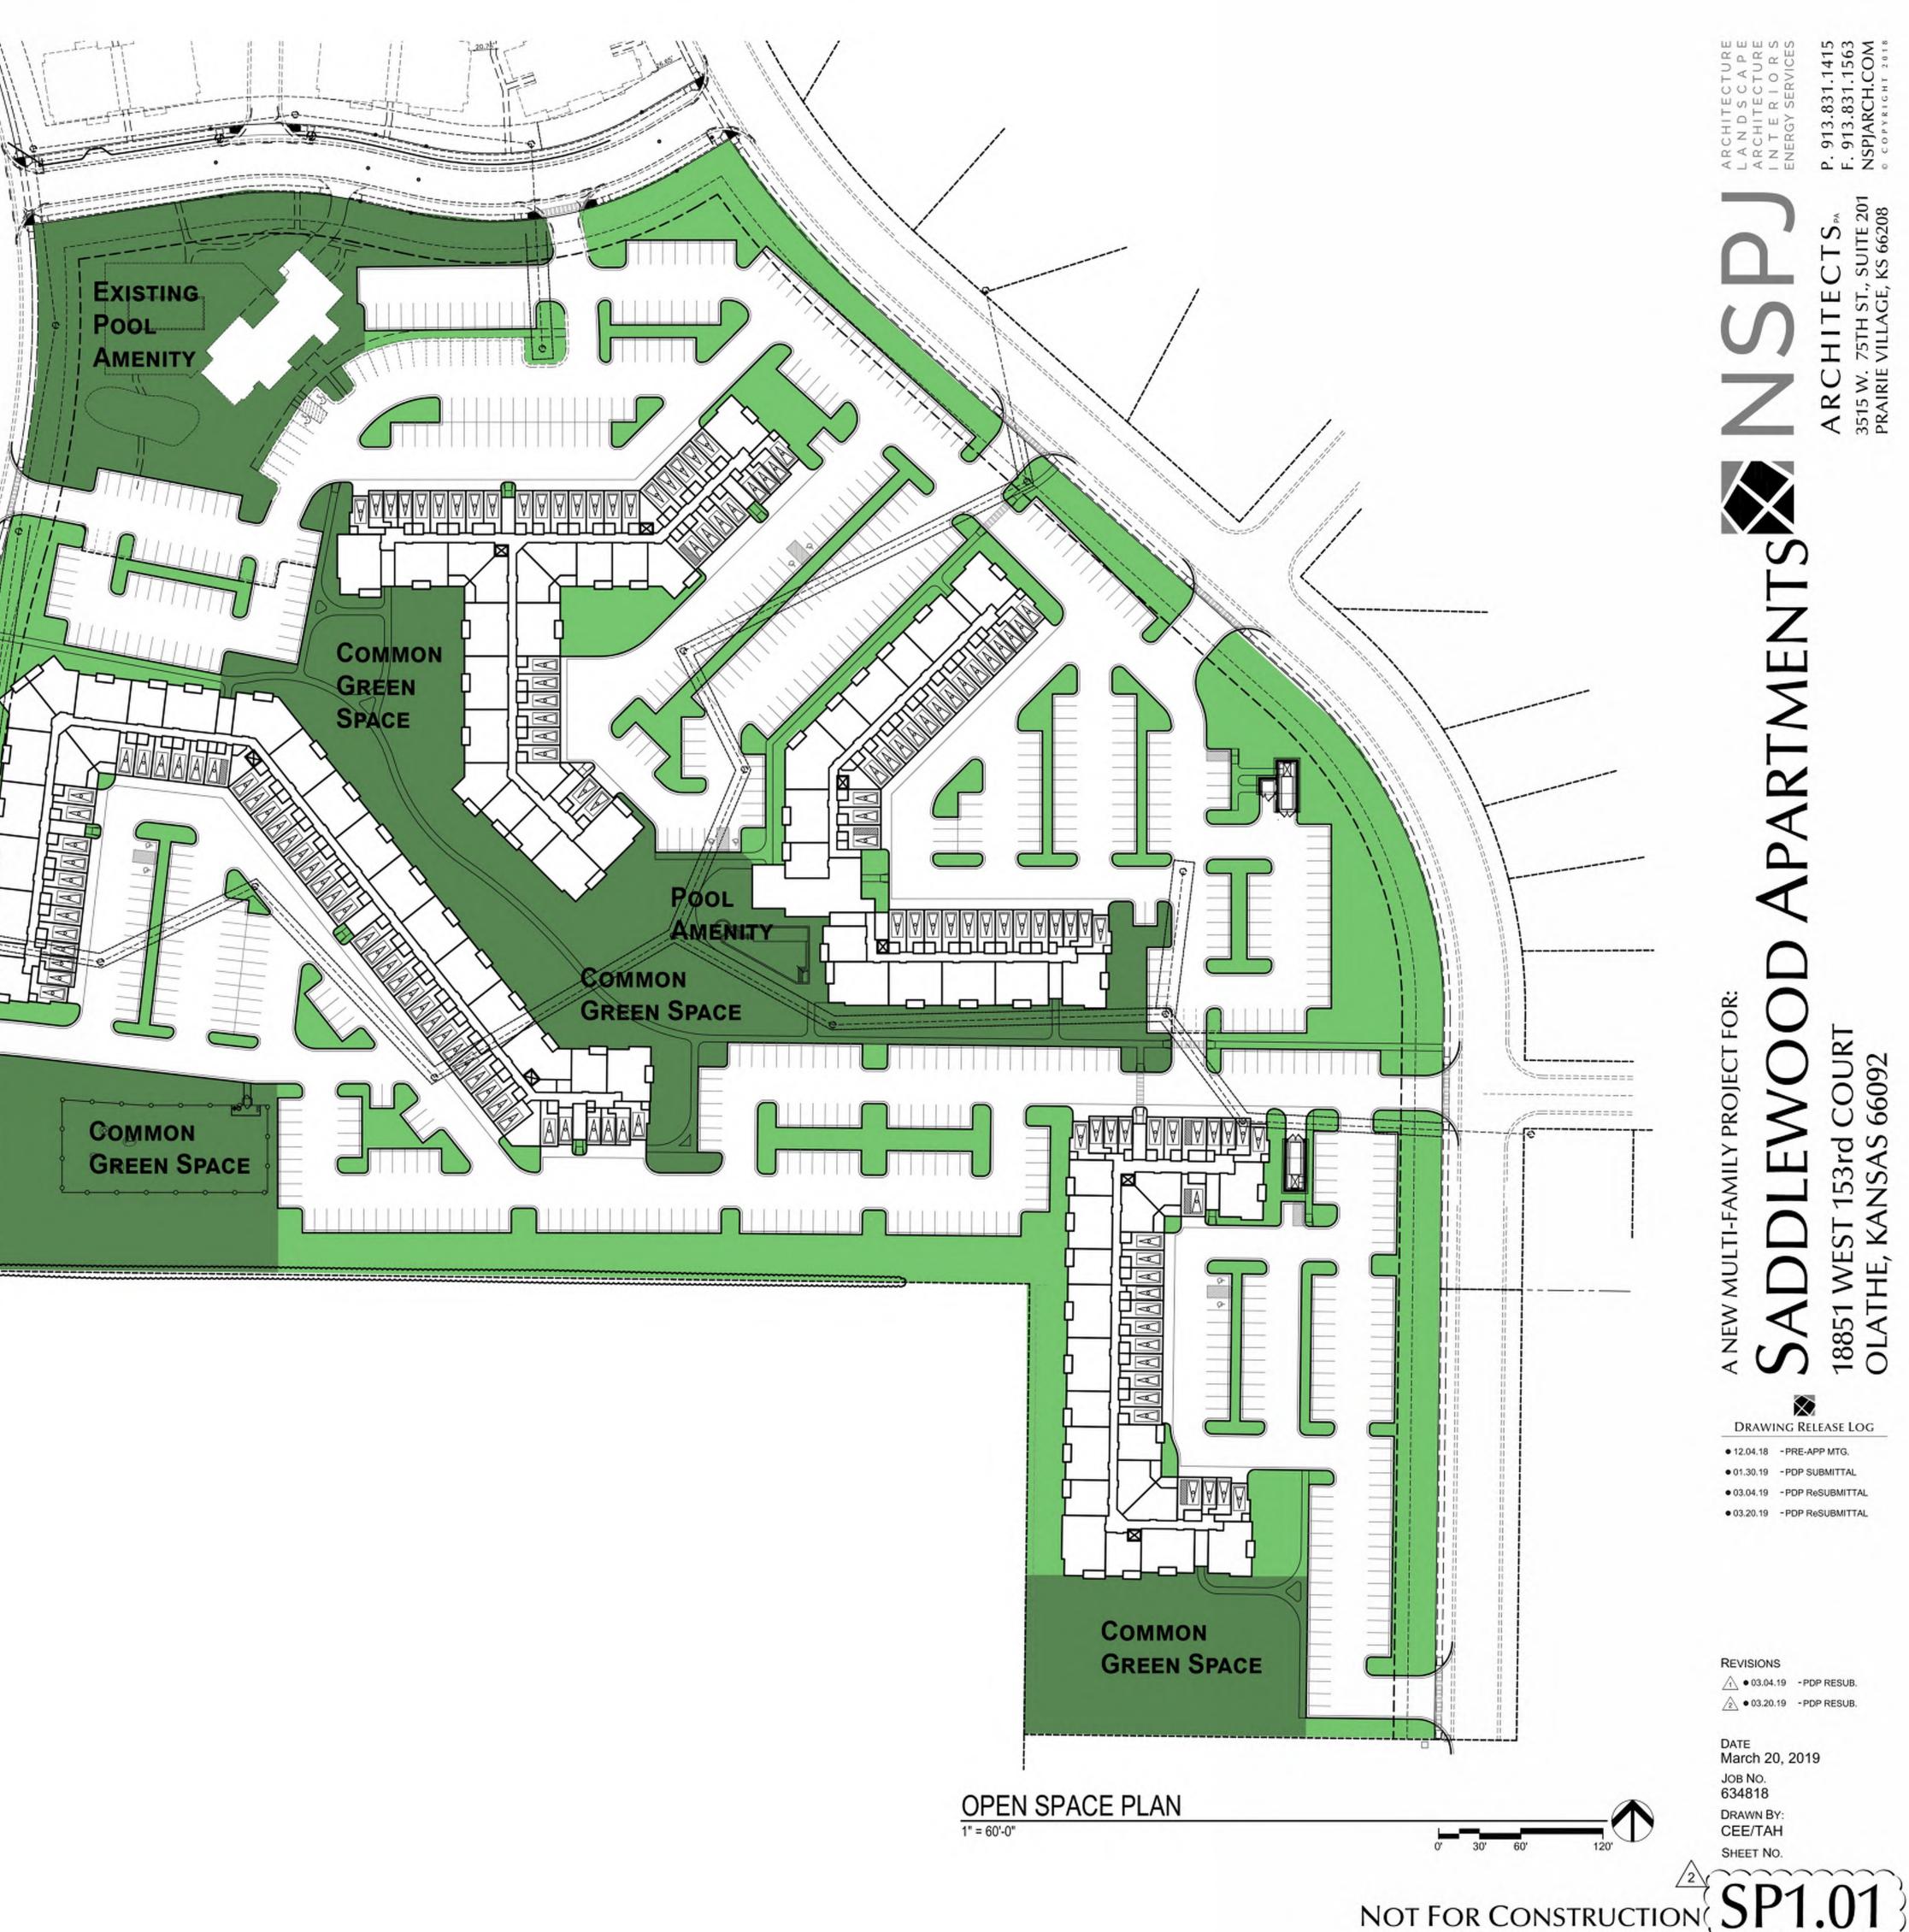




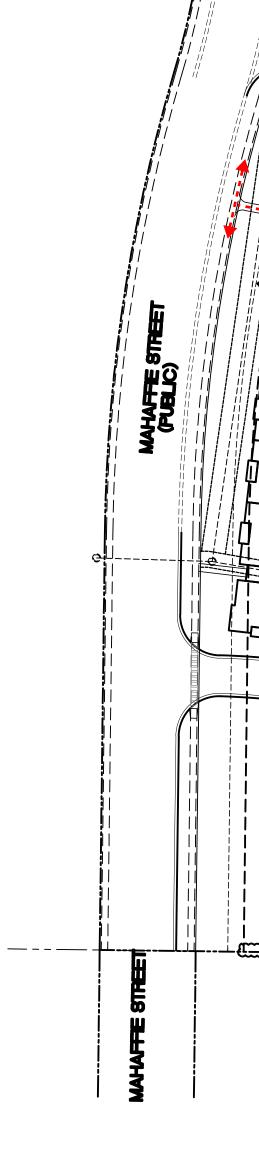

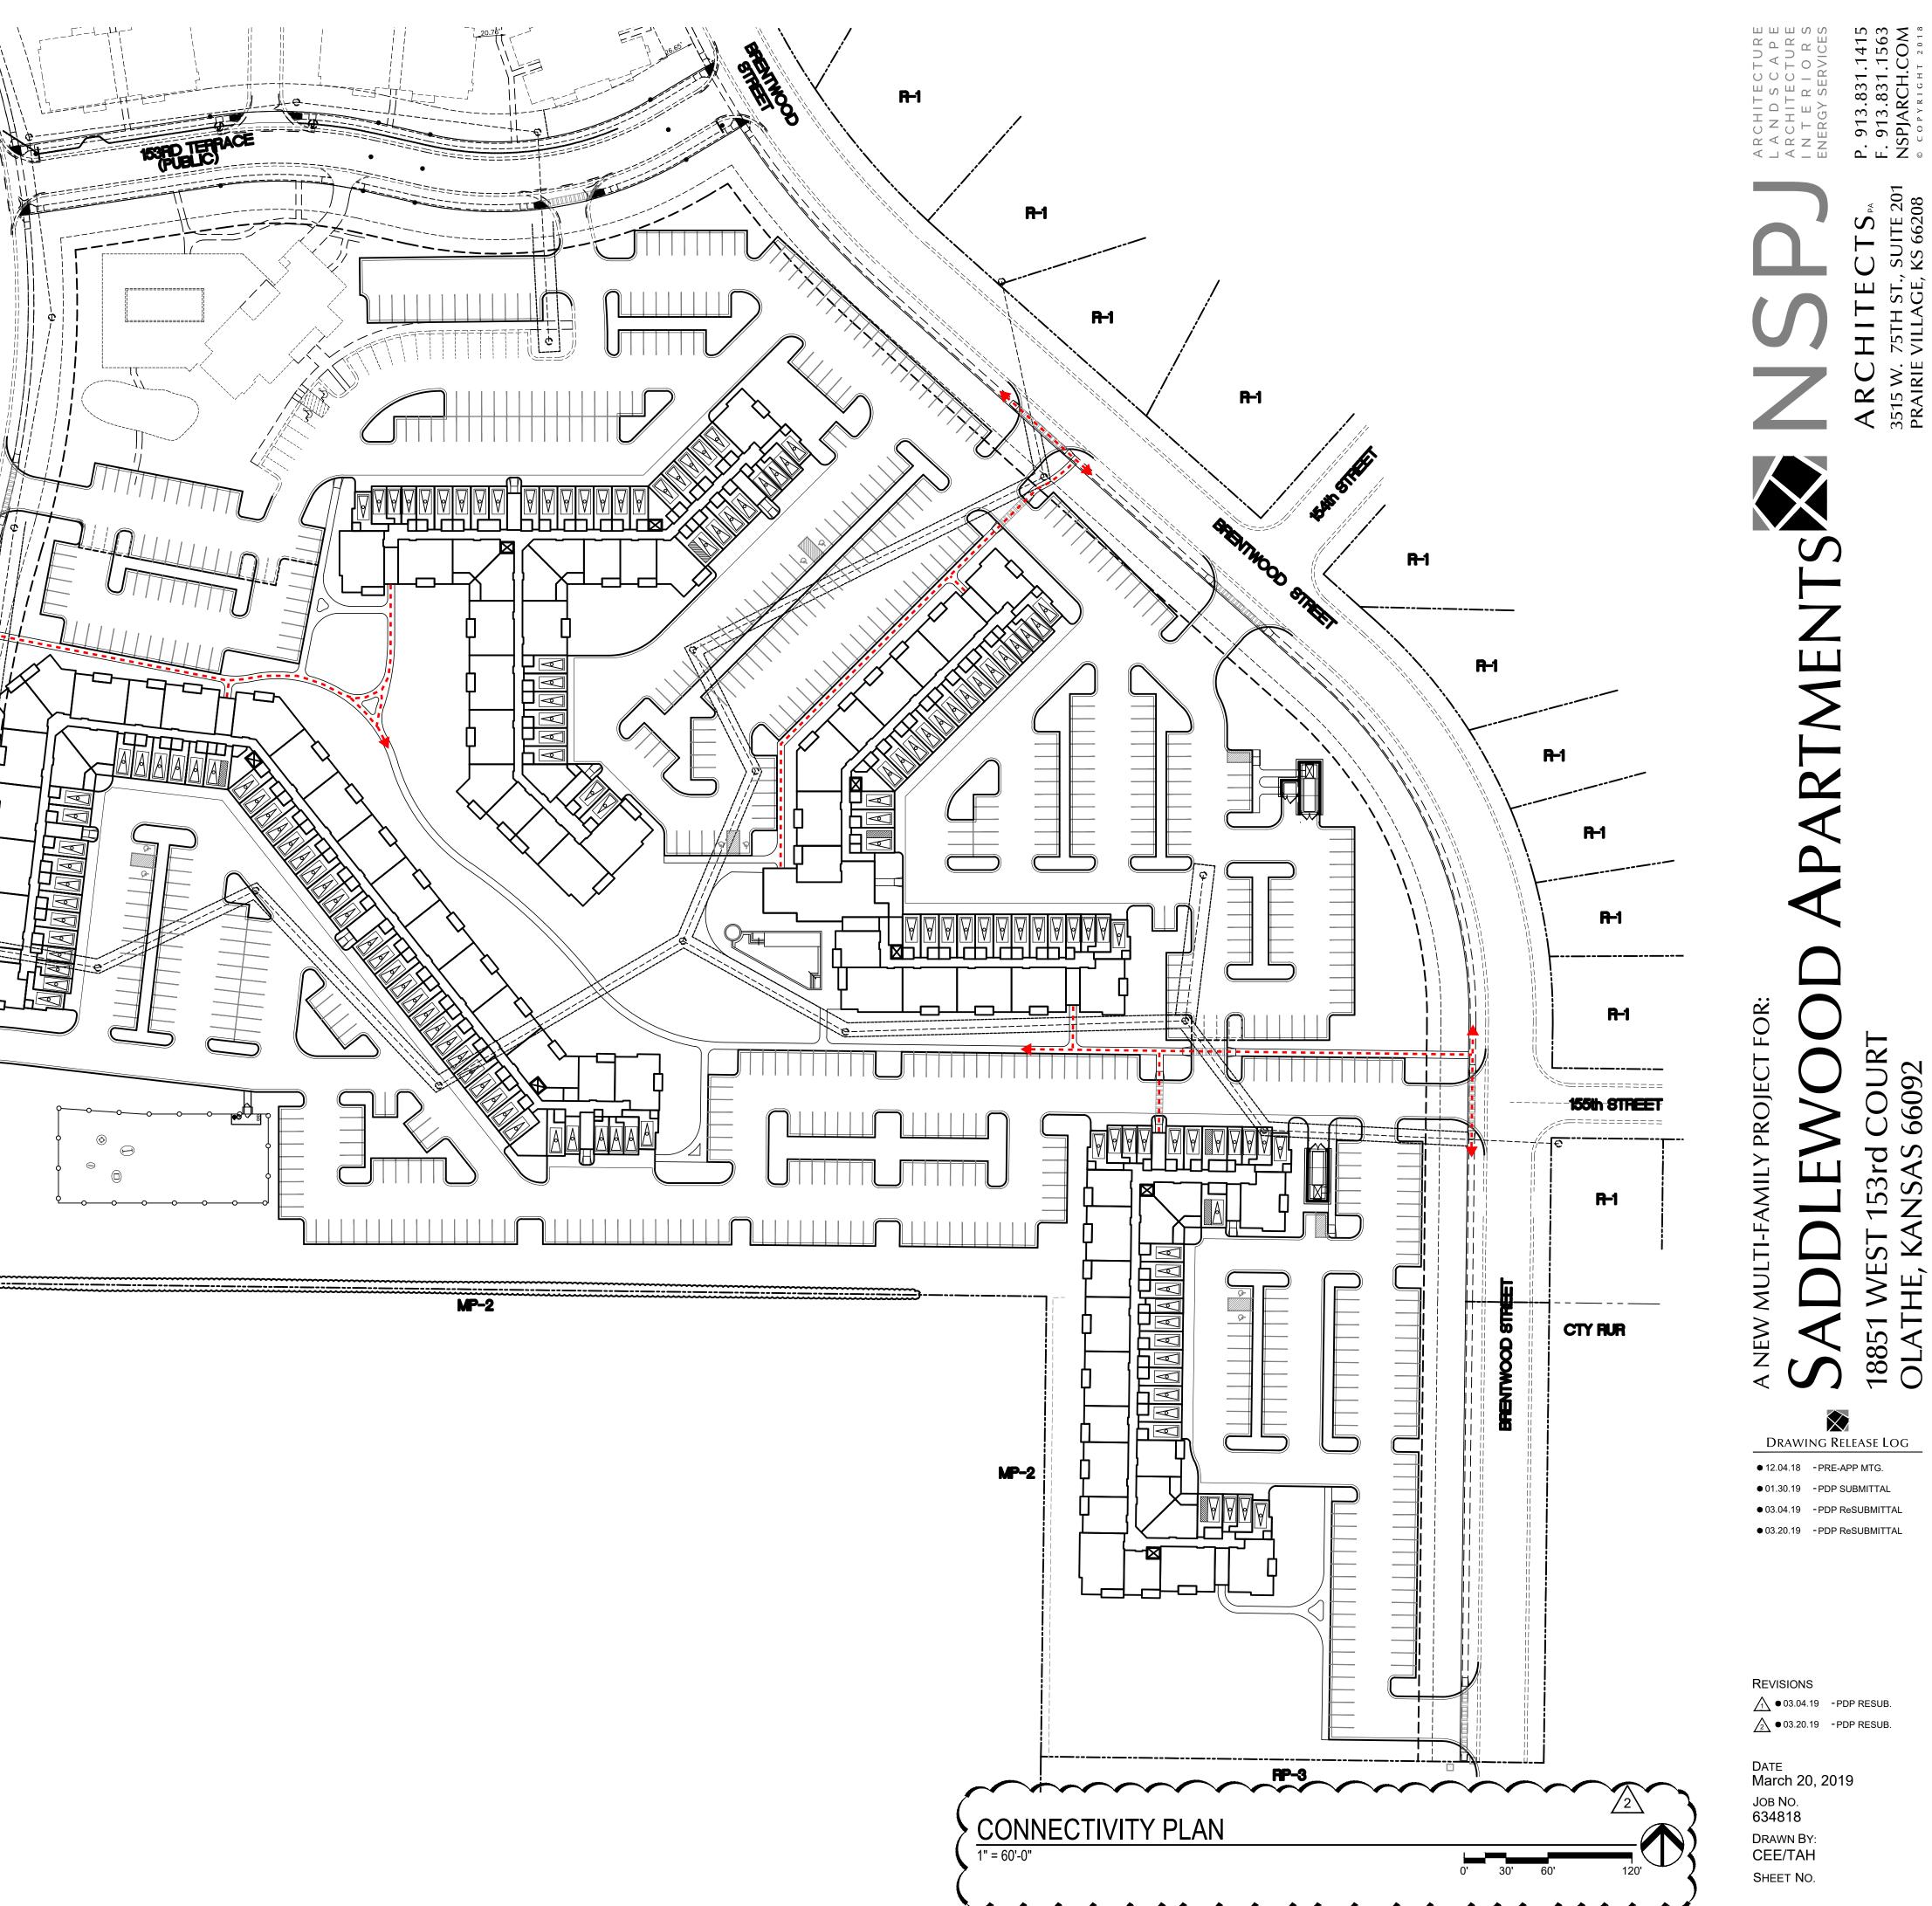NOT FOR CONSTRUCTION SP1.02

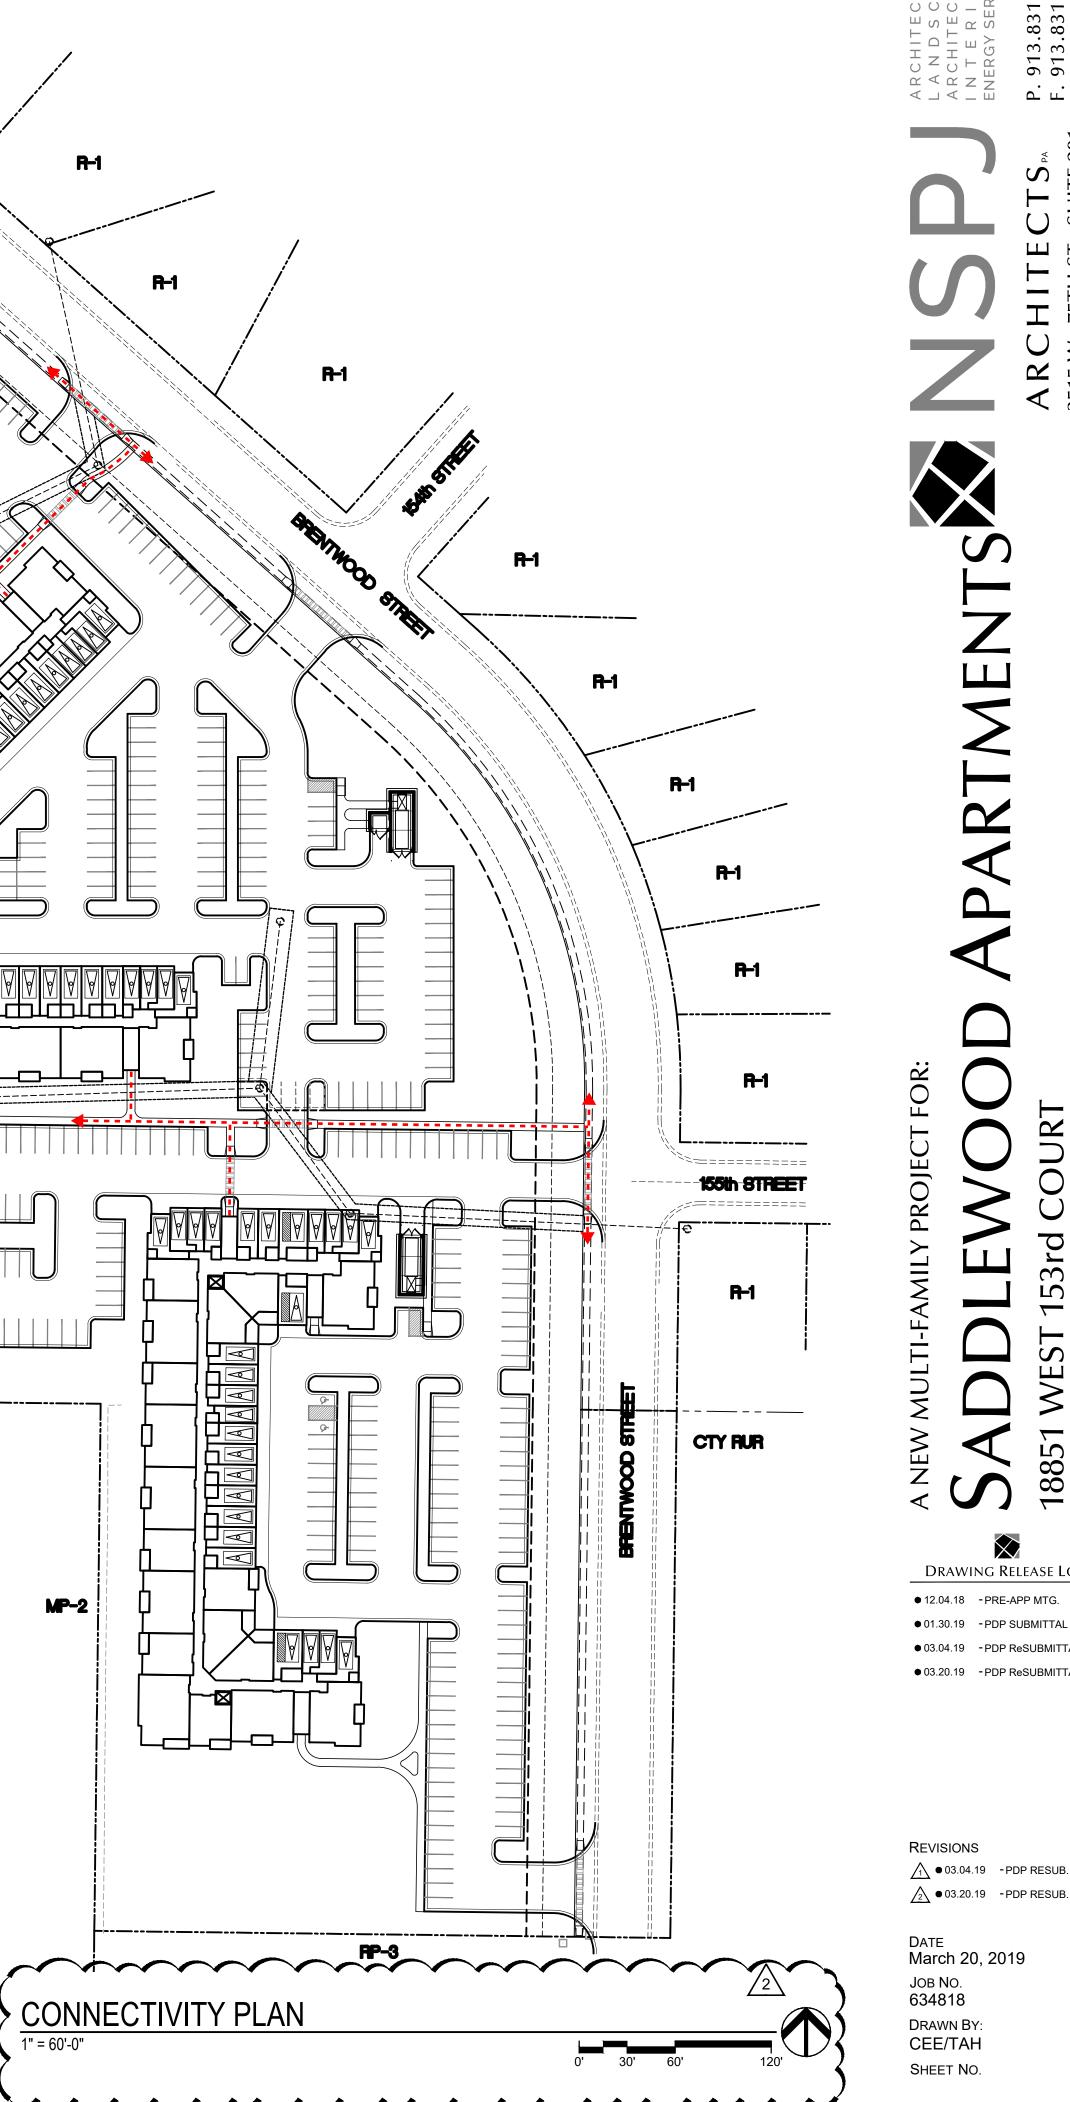

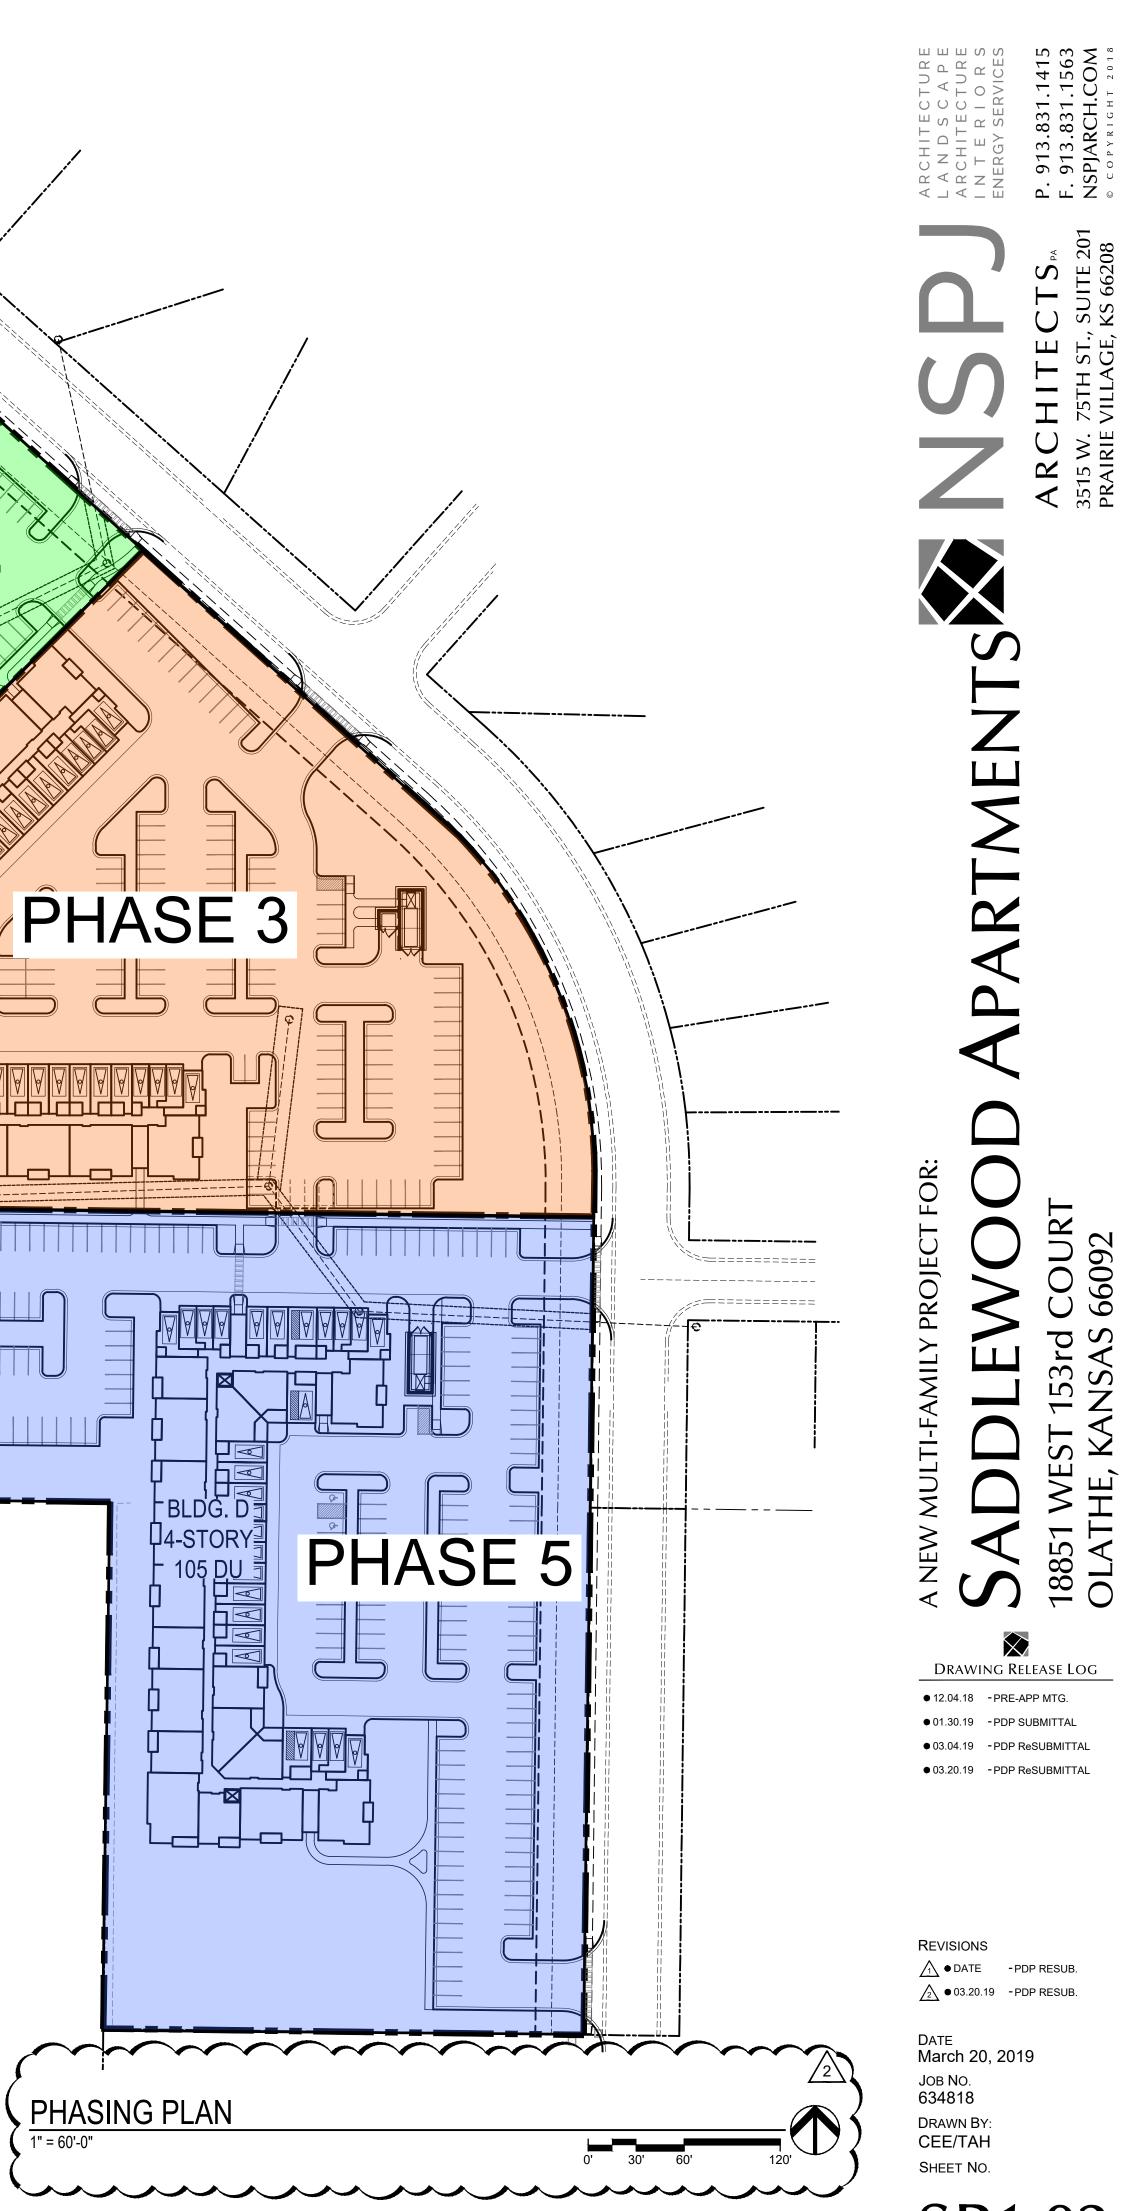

NOT FOR CONSTRUCTION SP1.03

COMPOSITION ROOF AT 4:12 -PITCH

ROOFTOP MECHANICAL EQUIPMENT BEYOND - HIDDEN BEHIND ROOF

HARDIE LAP SIDING (2) 8\* EXPOSURES THEN (1) 4\* EXPOSURE, REPEAT 5/4x12 HARDIE TRIM SMOOTH FINISH CORNER BD.-TYP. SLOPED COMPOSITE SILL OVER 5/4x SMOOTH FACE HARDIE TRIM

EYEBROW ROOF W/ PREFINISHED DARK BRONZE FLASHING & FASCIA - TYP. CUT STONE WATERTABLE

METAL RAILINGS TO 42" HGT.

FIXED PICTURE & AWNING WINDOWS - DARK BRONZE COLOR

PROJECTED BALCONIES W./ T-BAR FORM EDGING -DARK BRONZE COLOR HARDIE REVEAL PANEL

SYSTEM THIN STONE VENEER SLOPED COMPOSITE SILL – OVER 5/4x SMOOTH FACE HARDIE TRIM



PARTIAL ELEVATION BUILDING D

SCALE 1/8" = 1'-0"

## SIDE VIEW -VIEW FROM BRENTWOOD STREET

### PARTIAL ELEVATION BUILDING D SIDE VIEW -VIEW FROM BRENTWOOD STREET SCALE 1/8" = 1'-0"





REVISIONS

• 03.20.19 - PDP ReSUBMITTAL

DATE March 20, 2019 JOB NO. 634818 DRAWN BY: CEE/TAH SHEET NO.

NOT FOR CONSTRUCTION A3.00



### PARTIAL ELEVATION BUILDING B END VIEW - VIEW FROM BRENTWOOD STREET

SCALE 1/8" = 1'-0"



# PARTIAL ELEVATION BUILDING A

SCALE 1/8" = 1'-0"

ROOFTOP MECHANICAL EQUIPMENT BEYOND - HIDDEN BEHIND ROOF

HARDIE LAP SIDING (2) 8" EXPOSURES THEN (1) 4" EXPOSURE, REPEAT

5/4x12 HARDIE TRIM SNOOTH FINISH CORNER BD.-TYP. SLOPED COMPOSITE SILL OVER 5/4x SMOOTH FACE HARDIE TRIM EYEBROW ROOF W./ PREFINISHED DARK BRONZE FLASHING & FASCIA - TYP.

CUT STONE WATERTABLE METAL RAILINGS TO 42" HGT.

FIXED PICTURE & AWNING WINDOWS - DARK BRONZE COLOR PROJECTED BALCONIES W. T-BAR FORM EDGING -DARK BRONZE COLOR HARDIE REVEAL PANEL SYSTEM THIN STONE VENEER SLOPED COMPOSITE SILL OVER 5/4x SMOOTH FACE HARDIE TRIM



PREFINISHED METAL ROOF

PARAPET CAP

PARTIAL ELEVATION BUILDING A SCALE 1/8" = 1'-0"



## NOT FOR CONSTRUCTION A3.01

## END VIEW - VIEW FROM BRENTWOOD STREET

BEHIND ROOF

COMPOSITION ROOF at 4:12 PITCH

HARDIE LAP SIDING

(2) 8" EXPOSURES THEN

(1) 4" EXPOSURE, REPEAT

FINISH CORNER BD.-TYP.

- SLOPED COMPOSITE SILL

EYEBROW ROOF W/

HARDIE TRIM

OVER 5/4x SMOOTH FACE

PREFINISHED DARK BRONZE

FLASHING & FASCIA - TYP.

CUT STONE WATERTABLE

FIXED PICTURE & AWNING

PROJECTED BALCONIES W./

T-BAR FORM EDGING -

DARK BRONZE COLOR

THIN STONE VENEER

SLOPED COMPOSITE SILL

OVER 5/4x SMOOTH FACE

SYSTEM

HARDIE TRIM

HARDIE REVEAL PANEL

METAL RAILINGS TO 42" HGT.

WINDOWS - DARK BRONZE COLOR

5/4x12 HARDIE TRIM SNOOTH

ROOFTOP MECHANICAL EQUIPMENT BEYOND - HIDDEN

NEW

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DRAWING RELEASE LOG

• 12.04.18 - PRE-APP MTG.

• 01.30.19 - PDP SUBMITTAL

• 03.04.19 - PDP ReSUBMITTAL

REVISIONS

DATE

JOB NO. 634818 DRAWN BY: CEE/TAH SHEET NO.

March 4, 2019

1885 OLA

SIDE VIEW - VIEW FROM INTERNAL PARKING


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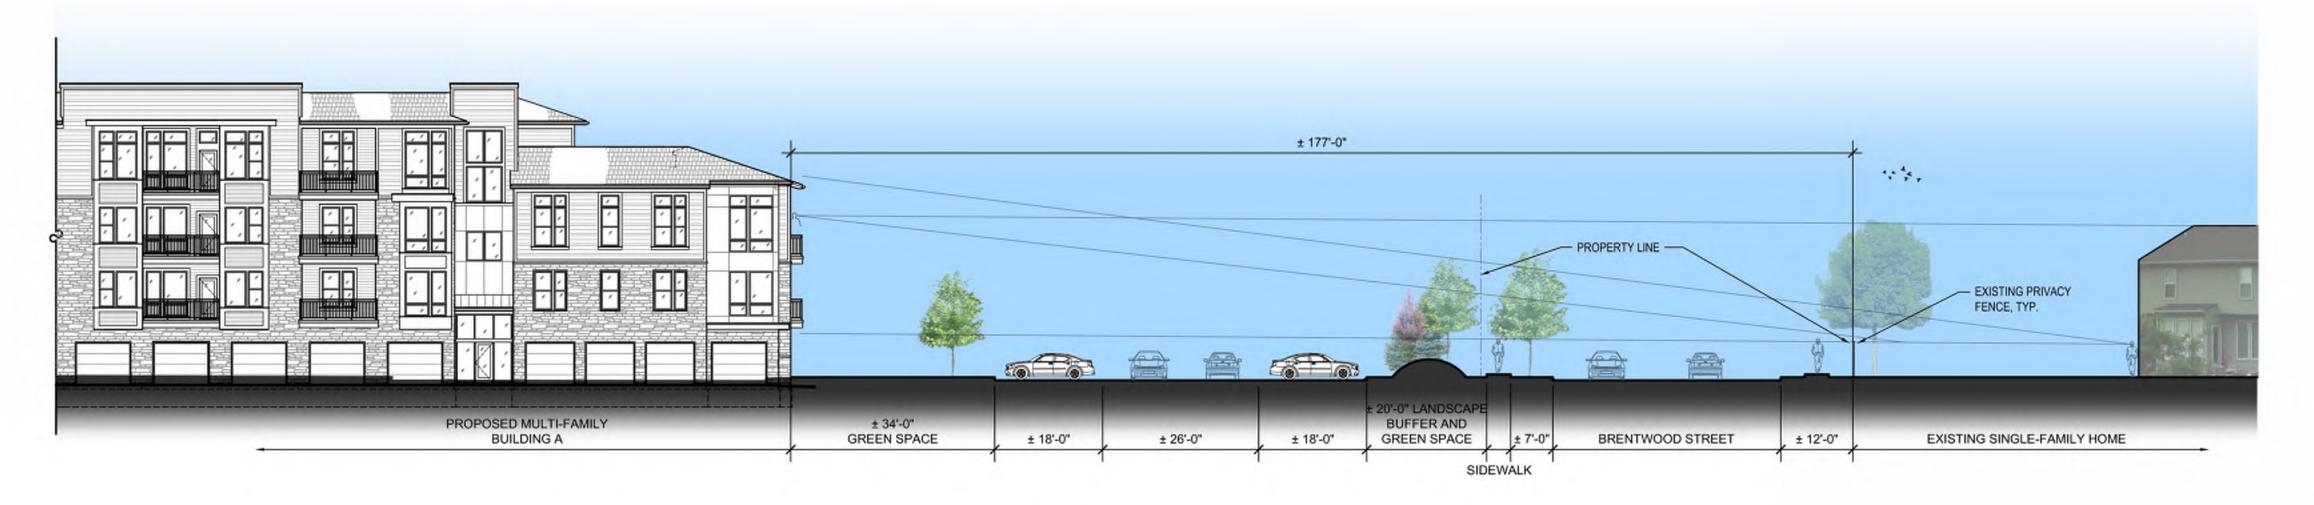
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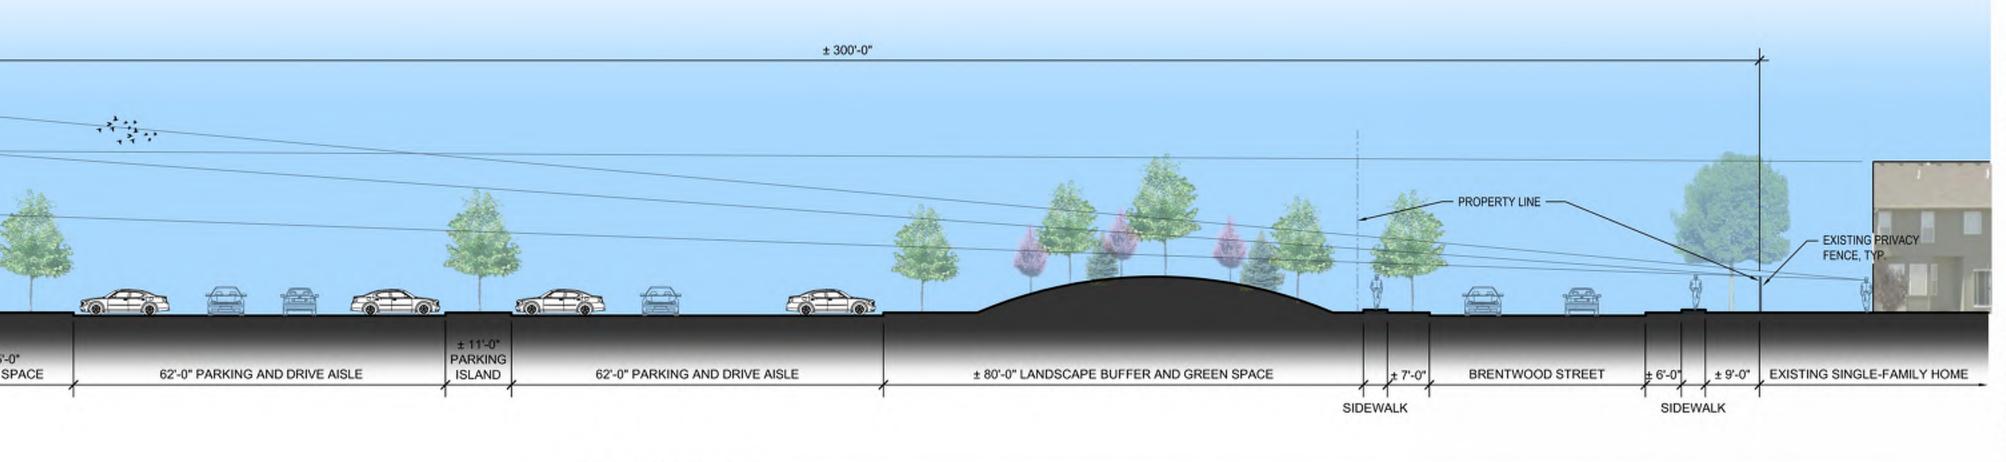
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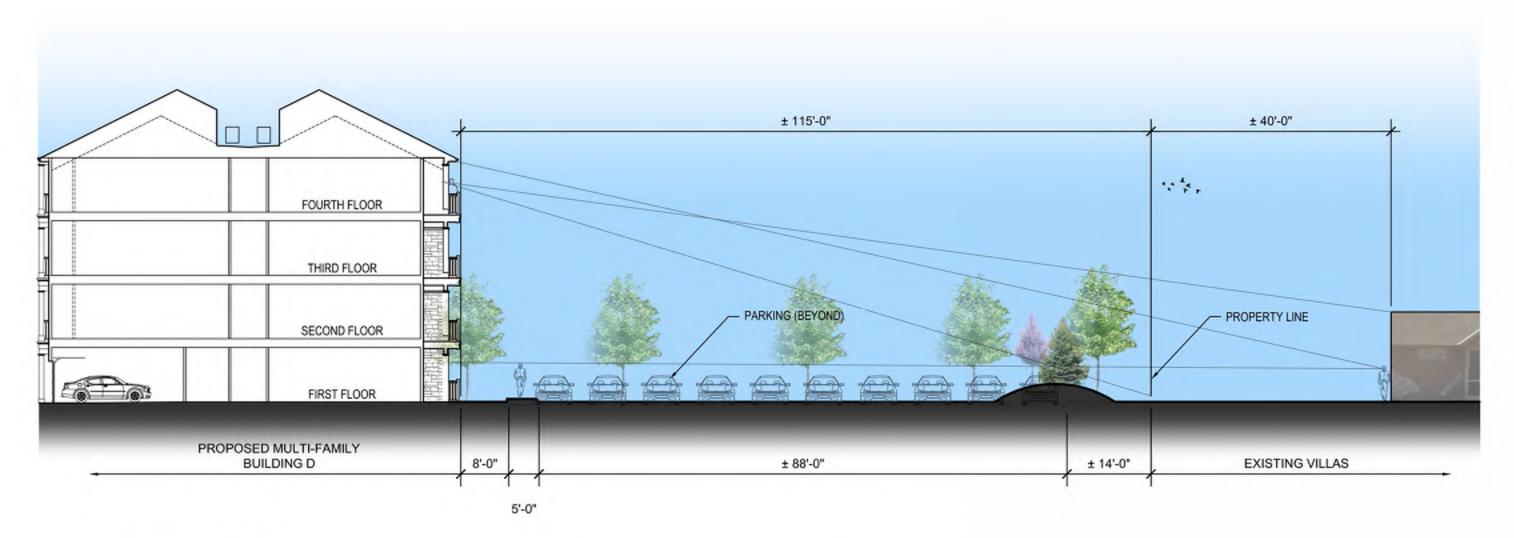








3 SITE SECTION 1/16" = 1'-0"

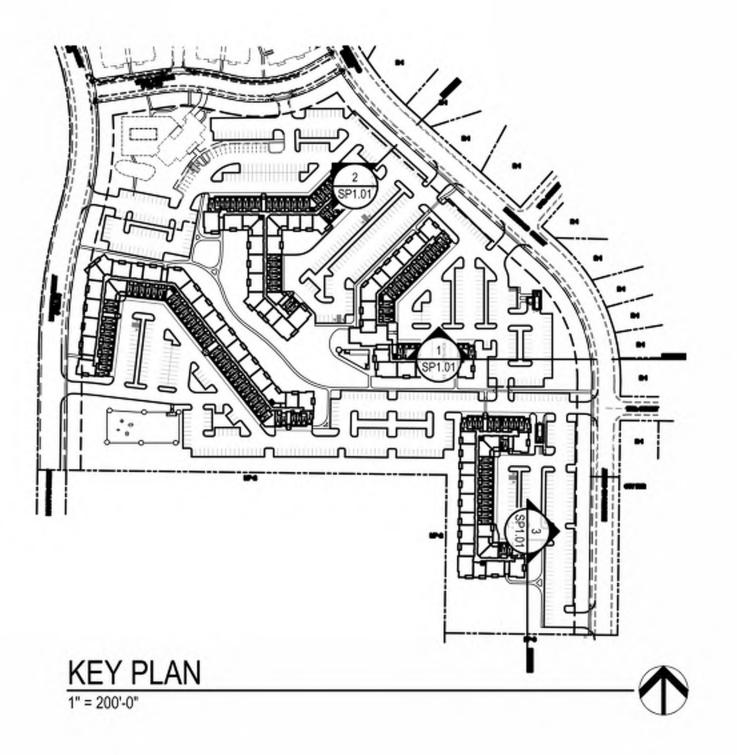



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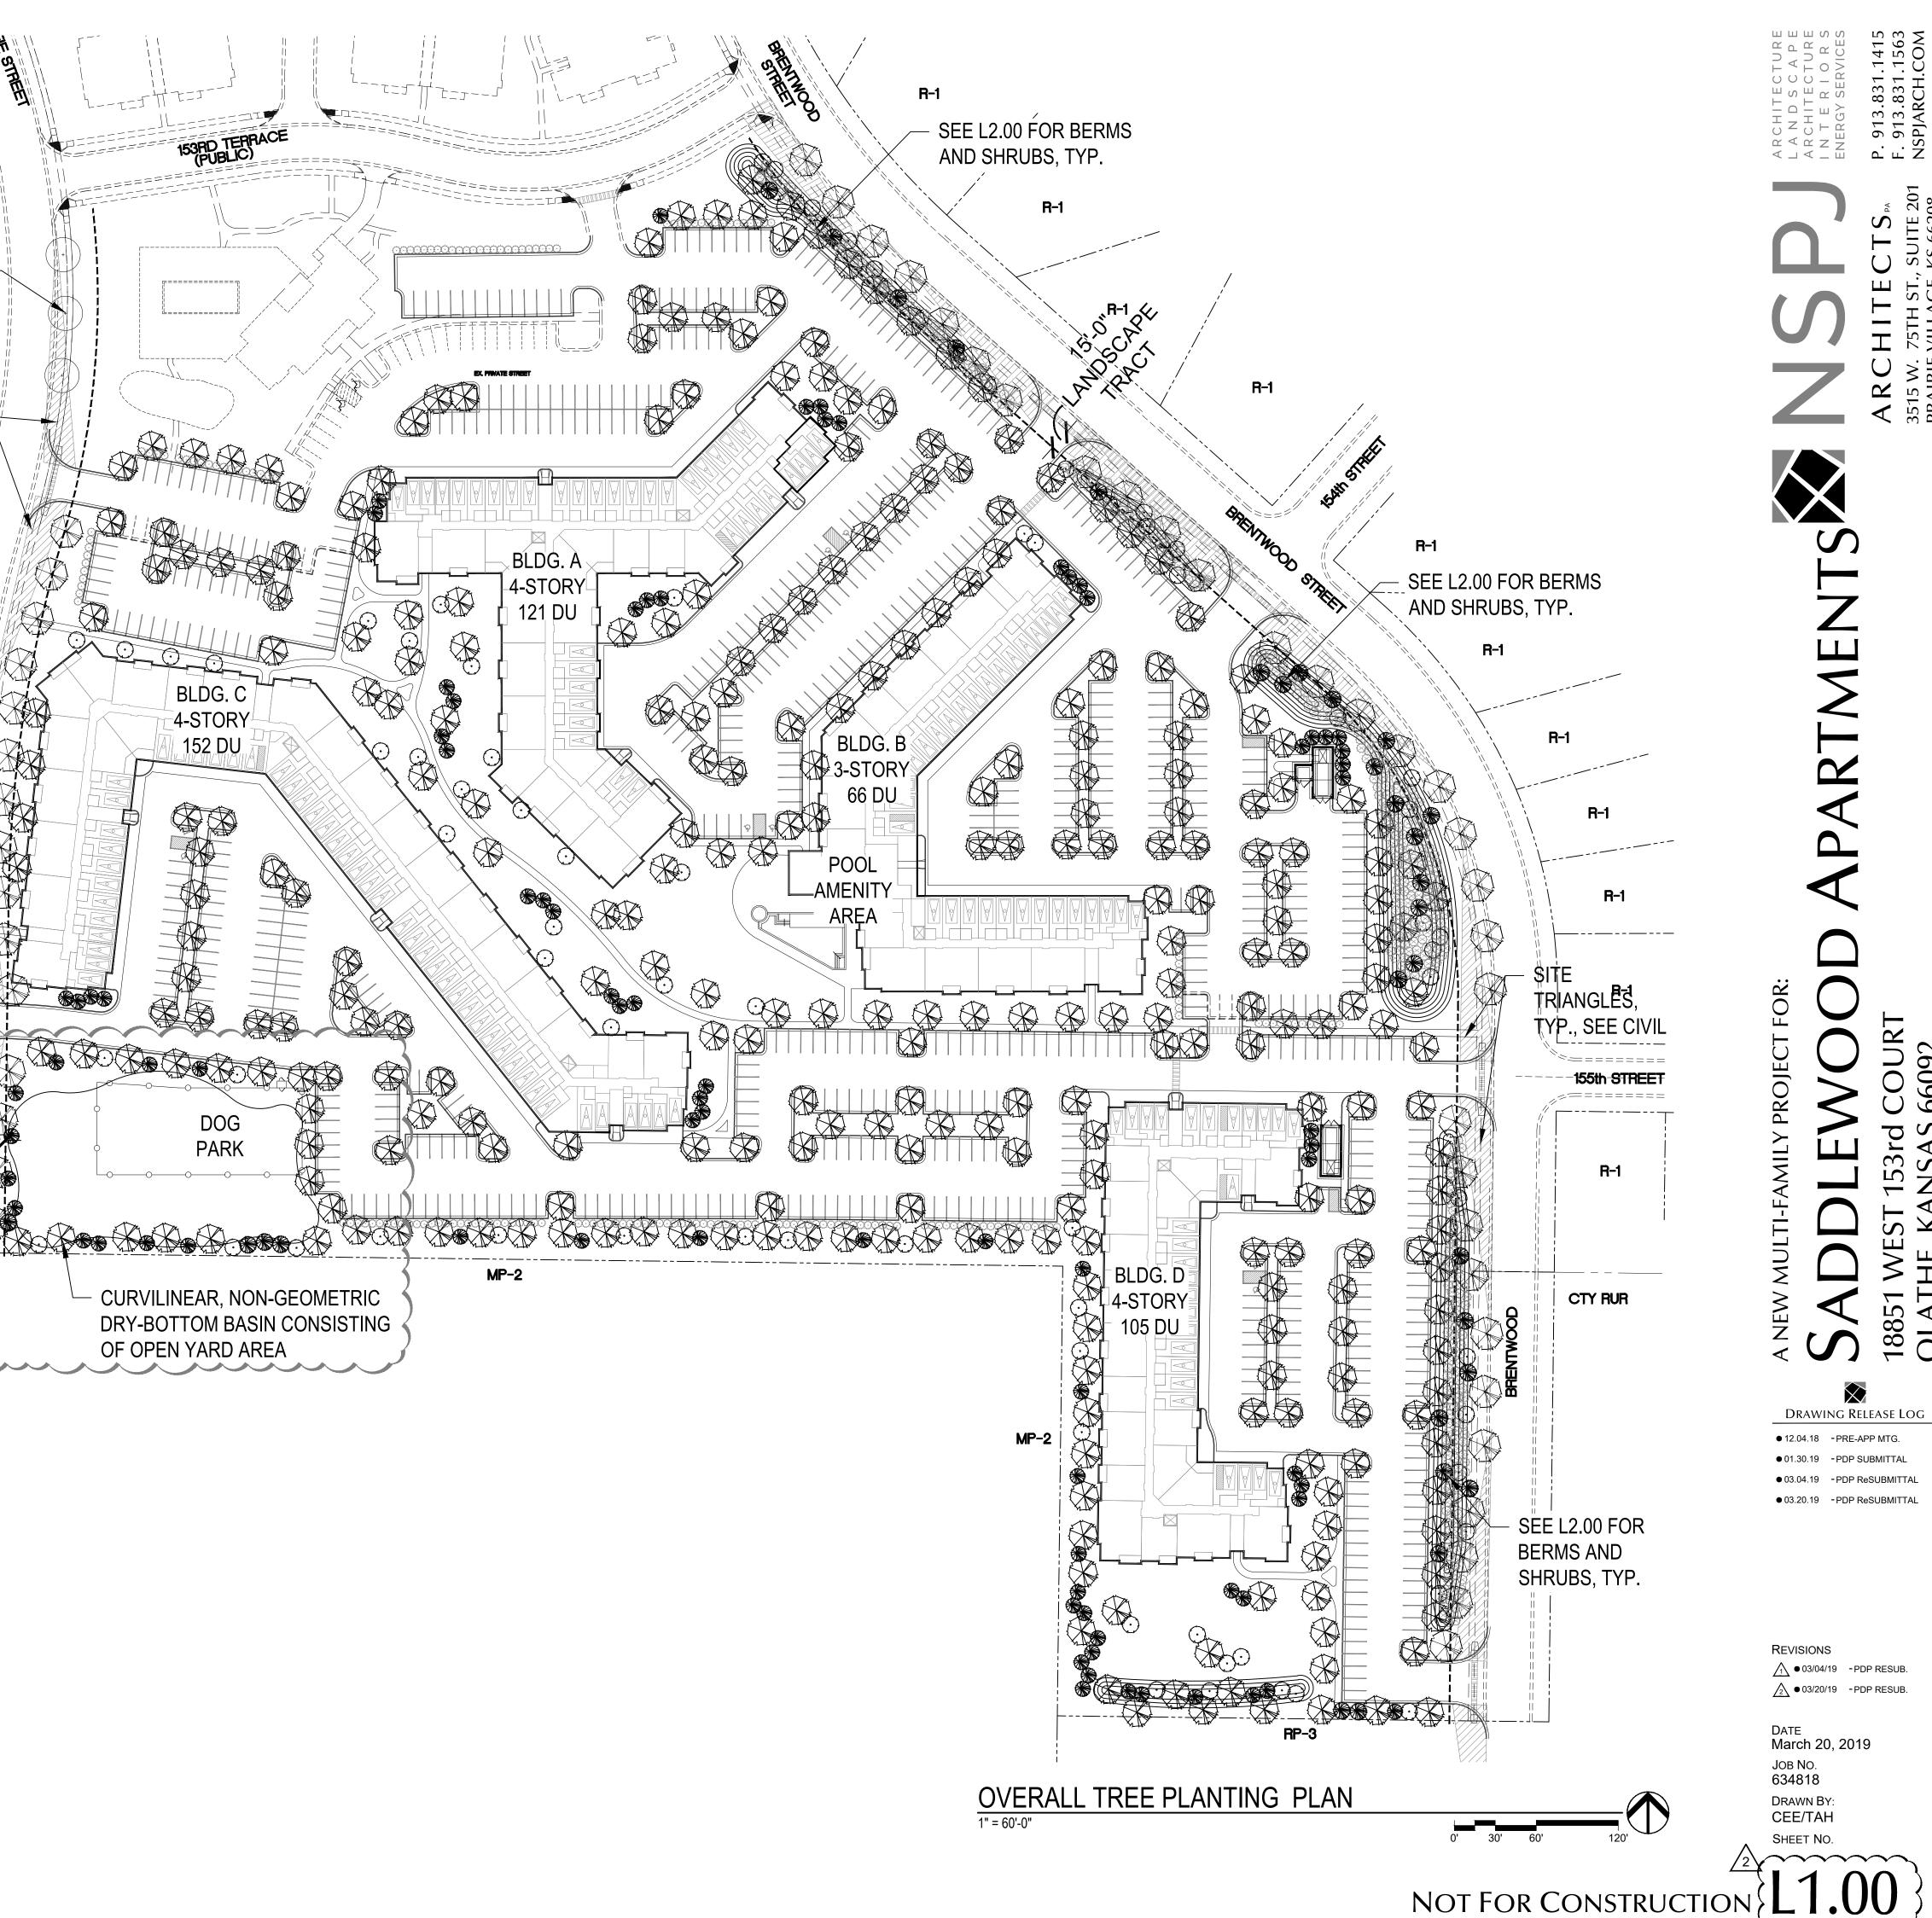


REVISIONS • 03.04.19 - PDP RESUB. • 03.20.19 - PDP RESUB.

Date March 20, 2019 JOB NO. 634818 DRAWN BY: CEE/TAH SHEET NO.

			-	$\sim$	
	Common Name	Botanical Name	-	Size Notes	
Columna ARM	Armstrong Maple	Acer rubrum 'Armstrong'	$\rightarrow$	2.5" Cal. B&B	
CHB	Carpinus betulus 'Fastigiata'	Columnar Hornbeam		2.5" Cal. 8&B	
OM HOK	Acer saccharum 'Endowment' Quercus macdanielii 'Clemons'	Columnar Sugar Maple Heritage Oak		2.5" Cal. B&B 2.5" Cal. B&B	
RPO	Quercus robur x bicolor 'Long'	Columnar Regal Prince Oak	$\rightarrow$	2.5" Cal. B&B	
Shade T NBM	Autumn Blaze Maple	Acer x fermoni 'Autumn Blaze'	$\rightarrow$	2.5" Cal. B&B	
AFM	Autumn Fantasy Maple	Acer x fermoni 'Autumn Fantasy'		2.5" Cal. B&B	
BCY	Common Baldcypress	Taxodium distichum	$\rightarrow$	2.5" Cal. B&B 2.5" Cal. B&B	
	Brandywine Red Maple Crimson Queen Red Maple	Acer rubrum 'Brandywine' Acer platanoides 'Crimson Queen'	-(-	2.5" Cal.   B&B 2.5" Cal.   B&B	
FEM	Frontier Elm	Ulmus carpinifolia x parvifolia 'Frontier'		2.5" Cal. B&B	EXISTING TREES
FM GNK	Fall Fiesta Sugar Maple Autumn Gold Ginko	Acer saccharum 'Fall Fiesta' Ginko biloba 'Autumn Gold'	$\rightarrow$	2.5" Cal. B&B 2.5" Cal. B&B	TO REMAIN
HOK	Heritage Oak	Quercus macdanielii 'Clemons'	$\rightarrow$	2.5" Cal. / B&B	
LL	Greenspire Littleleaf Linden	Tilia cordata 'Greenspire'		2.5" Cal. B&B	1 I 1 I
_PT _SM	London Plane Tree Legacy Sugar Maple	P. x acerfolia 'Bloodgood' Acer saccharum 'Legacy'		2.5" Cal. B&B 2.5" Cal. B&B	 
VSM	Norwegian Sunset Maple	Acer truncatum x A. platanoides 'Keithsform		2.5" Cal. B&B	
OGM	October Glory Red Maple	Acer rubrum 'October Glory'		2.5" Cal. B&B	SITE
PSM ROK	Pacific Sunset Maple Red Oak	Acer truncatum x A. platanoides 'Warrenred Quercus rubra		2.5" Cal.   B&B 2.5" Cal.   B&B	TRIANGLES,
SGM	Sienna Glen Maple	Acer x fermoni 'Sienna'	-	2.5" Cal. B&B	TYP., SEE CIVIL -
SKH	Skyline Honeylocust	Gleditsia triacanthos 'Skyline'	-	2.5" Cal. B&B	
SOK	Shumard Oak Sun Valley Maple	Quercus shumardii Acer rubrum 'Sun Valley'	$\rightarrow$	2.5" Cal. B&B 2.5" Cal. B&B	
WO	Swamp White Oak	Quercus bicolor		2.5" Cal. B&B	
EL	Zelkova	Zelkova serrata 'Green Vase'	7	2.5" Cal. ) B&B	
verare	Columnar Zelkova en Trees	Zelkova serrata 'Musashino'	$\rightarrow$	2.5" Cal. B&B	<b>/</b> / <i>//</i>
SP	Bakeri Blue Spruce	Picea pungens 'Bakeri'	-	6'Ht B&B	,
INS	Columnar Norway Spruce	Picea abies 'Cupressina'	>	6' Ht.   B&B	Į,
RC WS	Juniperus virginiana Norway Spruce	Red Cedar Picea abies	-(-	6' Ht. B&B 6' Ht. B&B	Ĵ/
RSS	Riverside Upright Spruce	Picea omorika 'Riverside'	$\rightarrow$	6'HL B&B	<u> </u>
BS	Serbian Spruce	Picea omorika		6' Ht. / B&B	
VSS Drname	Welspire Spruce ntal Trees	Picea mariana "Wellspire'	$\rightarrow$	6'Ht B&B	
BC	Coralburst Crabapple	Malus 'Coralburst'		1" cal B&B	
PP	Crimson Pointe Plum	Prunus x cerasifera 'Cripoizam'	7	1" cal B&B	
RB	Eastern Redbud Flowering Dogwood	Cercis Canadensis Cornus Florida		1" cal B&B 1" cal B&B	li' ii li li li
TL	Japanese Tree Lilac	Syringia reticulata		1" cal B&B	", <b>F.</b>
IAG	Evergreen Magnolia	Magnolia grandiflora 'DD Blanchard'	7	1" cal B&B	
RVB	Prairiefire Crabapple River Birch	Malus x 'Prairiefire' Betula Nigra	$\rightarrow$	1" cal B&B 1" cal B&B	
BM	Sweetbay Magnolia	Magnolia virginiana v .australis		1" cal B&B	
SC	Spring Snow Crabapple	Malus 'Spring Snow'		1" cal B&B	
VB VBD	Serviceberry Whitebud	Amelanchier canadensis Cersis Canadensis 'White Bud'	-	1" cal B&B 1" cal B&B	
		PLANT MATERIAL AND IS SUBJECT TO CHANGES	. (		
NDSCAP	E REQUIREMENTS (OLATHE):		(	$/_1$ )	
IREELIK	REES (18.30.130 G): 1 TREE PER 40 L.F. RF				
RENTWO	DD STREET = 1,257 L.F. /40 = 31				
/IAHAFF <b>I</b> E	STREET = 688 L.F. /40 = 17	15 NEW, 3 EXISTING			
		,			
a. A B		BUFFER L BE PROVIDED ALONG THE SIDE LOT LINE OF A			
a. A B b. THE	UFFER REQUIRED BY THIS SECTION SHAL E REQUIRED PERIMETER LANDSCAPE ARE	BUFFER L BE PROVIDED ALONG THE SIDE LOT LINE OF AB A SHALL BE LOCATED OUTSIDE OF THE FENCED	AREA OI	THE	
a. A B b. THE DEV FIN/	UFFER REQUIRED BY THIS SECTION SHAL E REQUIRED PERIMETER LANDSCAPE ARE VELOPMENT BETWEEN THE FENCE AND TH AL SITE DEVELOPMENT PLAN APPROVAL.	BUFFER L BE PROVIDED ALONG THE SIDE LOT LINE OF AE A SHALL BE LOCATED OUTSIDE OF THE FENCED HE STREET, UNLESS THIS REQUIREMENT IS OTHE	AREA OI	THE	
a. A B b. THE DEV FIN/	UFFER REQUIRED BY THIS SECTION SHAL E REQUIRED PERIMETER LANDSCAPE ARE /ELOPMENT BETWEEN THE FENCE AND TH	BUFFER L BE PROVIDED ALONG THE SIDE LOT LINE OF AE A SHALL BE LOCATED OUTSIDE OF THE FENCED HE STREET, UNLESS THIS REQUIREMENT IS OTHE	AREA OI	THE	
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a. A B b. THE DEV FIN/ c. BUF YPE 3 BUI	UFFER REQUIRED BY THIS SECTION SHAL E REQUIRED PERIMETER LANDSCAPE ARE /ELOPMENT BETWEEN THE FENCE AND TH AL SITE DEVELOPMENT PLAN APPROVAL. FFERS ARE NOT REQUIRED ALONG THE FF FFER ALONG BRENTWOOD STREET PROV FIONS) = +/- 1,257FT / 100FT = 19 SHADE TF	BUFFER L BE PROVIDED ALONG THE SIDE LOT LINE OF AE A SHALL BE LOCATED OUTSIDE OF THE FENCED HE STREET, UNLESS THIS REQUIREMENT IS OTHE RONT PROPERTY LINE.	AREA OI RWISE I SS STRE	THE MODIFIED WITH EET AND DRIVE	
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a. A B b. THE DEV FIN/ c. BUF YPE 3 BUI ITERSECT HRUBS/G ESIDENTI	UFFER REQUIRED BY THIS SECTION SHAL E REQUIRED PERIMETER LANDSCAPE ARE /ELOPMENT BETWEEN THE FENCE AND TH AL SITE DEVELOPMENT PLAN APPROVAL. FFERS ARE NOT REQUIRED ALONG THE FF FFER ALONG BRENTWOOD STREET PROV FIONS) = +/- 1,257FT / 100FT = 19 SHADE TF RASSES REQUIRED AND PROVIDED. AL LOTS (18.30.130 K): 1 TREE PER DWELI <u>REQUIRE</u>	BUFFER L BE PROVIDED ALONG THE SIDE LOT LINE OF AE A SHALL BE LOCATED OUTSIDE OF THE FENCED HE STREET, UNLESS THIS REQUIREMENT IS OTHE RONT PROPERTY LINE. IDED AT CITY'S REQUEST. TOTAL FRONTAGE (LE REES, 13 ORNAMENTAL TREES, 19 EVERGREEN TH LING UNIT D: PROVIDED:	AREA OI RWISE I SS STRE	THE MODIFIED WITH EET AND DRIVE	
a. A B b. THE DEV FIN/ c. BUF YPE 3 BUI ITERSECT HRUBS/G ESIDENTI OTAL DU	UFFER REQUIRED BY THIS SECTION SHAL E REQUIRED PERIMETER LANDSCAPE ARE VELOPMENT BETWEEN THE FENCE AND TH AL SITE DEVELOPMENT PLAN APPROVAL. FFERS ARE NOT REQUIRED ALONG THE FF FFER ALONG BRENTWOOD STREET PROV FIONS) = +/- 1,257FT / 100FT = 19 SHADE TF RASSES REQUIRED AND PROVIDED. AL LOTS (18.30.130 K): 1 TREE PER DWELI REQUIRE = 444 444 TREE	BUFFER L BE PROVIDED ALONG THE SIDE LOT LINE OF AE A SHALL BE LOCATED OUTSIDE OF THE FENCED HE STREET, UNLESS THIS REQUIREMENT IS OTHE RONT PROPERTY LINE. IDED AT CITY'S REQUEST. TOTAL FRONTAGE (LE REES, 13 ORNAMENTAL TREES, 19 EVERGREEN TH LING UNIT D: PROVIDED:	AREA OI RWISE I SS STRE REES, &	THE MODIFIED WITH EET AND DRIVE 440	
a. A B b. THE DEV FIN/ c. BUF YPE 3 BUI ITERSECT HRUBS/G ESIDENTI OTAL DU	UFFER REQUIRED BY THIS SECTION SHAL E REQUIRED PERIMETER LANDSCAPE ARE /ELOPMENT BETWEEN THE FENCE AND TH AL SITE DEVELOPMENT PLAN APPROVAL. FFERS ARE NOT REQUIRED ALONG THE FF FFER ALONG BRENTWOOD STREET PROV FIONS) = +/- 1,257FT / 100FT = 19 SHADE TH RASSES REQUIRED AND PROVIDED. AL LOTS (18.30.130 K): 1 TREE PER DWELD REQUIRED AND PROVIDED. AL LOTS (18.30.130 K): 1 TREE PER DWELD REQUIRED AND PROVIDED.	BUFFER L BE PROVIDED ALONG THE SIDE LOT LINE OF AB A SHALL BE LOCATED OUTSIDE OF THE FENCED TE STREET, UNLESS THIS REQUIREMENT IS OTHE RONT PROPERTY LINE. IDED AT CITY'S REQUEST. TOTAL FRONTAGE (LE REES, 13 ORNAMENTAL TREES, 19 EVERGREEN TH LING UNIT D: PROVIDED: S 444+ TREES	AREA OI RWISE I SS STRE REES, &	THE MODIFIED WITH EET AND DRIVE 440	
a. A B b. The DEV FIN/ c. BUF YPE 3 BUI ITERSECT HRUBS/G ESIDENTI OTAL DU ARKING A ROVIDED	UFFER REQUIRED BY THIS SECTION SHAL E REQUIRED PERIMETER LANDSCAPE ARE (ELOPMENT BETWEEN THE FENCE AND TH AL SITE DEVELOPMENT PLAN APPROVAL. FFERS ARE NOT REQUIRED ALONG THE FF FFER ALONG BRENTWOOD STREET PROV FIONS) = +/- 1,257FT / 100FT = 19 SHADE TF RASSES REQUIRED AND PROVIDED. AL LOTS (18.30.130 K): 1 TREE PER DWELL RASSES REQUIRED AND PROVIDED. AL LOTS (18.30.130 K): 1 TREE PER DWELL RASSES REQUIRED AND PROVIDED. AL LOTS (18.30.130 K): 1 TREE PER DWELL RASSES REQUIRED AND PROVIDED. AL LOTS (18.30.130 K): 1 TREE PER DWELL (OPTION 2). AND VEHICULAR USE AREAS- PERIMETER (18)	BUFFER L BE PROVIDED ALONG THE SIDE LOT LINE OF AE A SHALL BE LOCATED OUTSIDE OF THE FENCED HE STREET, UNLESS THIS REQUIREMENT IS OTHE RONT PROPERTY LINE. IDED AT CITY'S REQUEST. TOTAL FRONTAGE (LE REES, 13 ORNAMENTAL TREES, 19 EVERGREEN TH LING UNIT D: PROVIDED: S 444+ TREES (18.30.130 M.2): CONTINUOUS ROW OF SHRUBS 3 3.30.130 M.3):	AREA OI RWISE I SS STRE REES, &	THE MODIFIED WITH EET AND DRIVE 440	
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REPLACE WITH PLANTING SOIL MIX.. REFER TO L3.00 FOR PLANTING SOIL MIX 7. ALL MECHANICAL EQUIPMENT WILL BE SCREENED PER UDO REQUIREMENTS.





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#### PLANT LIST:

Evergre	een Shrubs			
DFY	Densiformis Yew	Taxus x media 'Densiformis'	5 Gal.	36" Ht.
GGB	Green Gem Boxwood	Buxus x 'Green Gem'	5 Gal.	36" Ht.
GMC	Gold Mop Cypress	Chamaecyparis pisifera 'Yellow Thread Branch'	5 Gal.	36" Ht.
SGJ	Sea Green Juniper	Juniperus chinensis 'Sea Green'	5 Gal.	36" Ht.
WGB	Winter Green Boxwood	Buxus microphylla 'Winter Green'	5 Gal.	36" Ht.
WYW	Wardii Yew	Taxus x media 'Wardii'	5 Gal.	36" Ht.
Decidio	ous Shrubs			
DBB	Dwarf Burning Bush	Euonymus Alatus 'Compacta'	2 Gal.	36" Ht.
DGW	Varigated Red Twigged Dogwood	Cornus sericea 'Bailhalo'	2 Gal.	36" Ht.
DRT	Dwarf Red Twig Dogwood	Cornus sericea 'Kelseyi'	2 Gal.	36" Ht.
KNR	Knockout Rose	Rosa knockout	2 Gal.	36" Ht.
LHS	Little Henry Sweetspire	Itea virginica 'Little Henry's Garnet'	2 Gal.	36" Ht.
MHV	Mohawk Viburnum	Viburnum x burkwoodii 'Mohawk'	2 Gal.	36" Ht.
MRV	Maresei Viburnum	Viburnum plicatum var. tomentosum 'Maresei'	2 Gal.	36" Ht.
SSV	Summer Snowflake Viburnum	Viburnum plicatum var. tomentosum 'Summer Sno	2 Gal.	36" Ht.
WTB	Winterberry	llex verticilata 'Red Sprite'/ Jim Dandy'	2 Gal.	36" Ht.

SEE L1.00 FOR TREE PLANTINGS

#### GENERAL NOTES:

1. EACH BIDDER SHALL VISIT THE SITE OF THE PROPOSED WORK AND EXAMINE THE SITE CONDITIONS. HE SHALL ALSO CAREFULLY EXAMINE THE DRAWINGS FOR THE PROPOSED WORK AND FAMILIARIZE HIMSELF WITH ALL CONDITIONS, WHICH MAY AFFECT THE PROPOSED WORK.

2. THE PLANTING PLAN GRAPHICALLY ILLUSTRATES OVERALL PLANT MASSINGS. EACH PLANT SPECIES MASSING SHALL BE PLACED IN THE FIELD TO UTILIZE GREATEST COVERAGE OF GROUND PLANE. THE FOLLOWING APPLIES FOR INDIVIDUAL PLANTINGS:

- A. CREEPING GROUNDCOVER SHALL BE A MINIMUM OF 6" FROM PAVING EDGE.
- B. ALL TREES SHALL BE A MINIMUM OF 3' FROM PAVING EDGE. C. ALL PLANTS OF THE SAME SPECIES SHALL BE EQUALLY SPACED APART AND PLACED FOR BEST
- AESTHETIC VIEWING. D. ALL SHRUBS SHALL BE A MINIMUM OF 2' FROM PAVED EDGE.

3. NOTIFY LANDSCAPE ARCHITECT 1 WEEK PRIOR TO ANTICIPATED START OF PLANT MATERIAL INSTALLATION. LANDSCAPE CONTRACTOR SHALL STAKE ALL PROPOSED PLANTING BED EDGES, SET OUT SHRUBS IN INTENDED LOCATIONS, AND STAKE TREE LOCATIONS FOR APPROVAL BY LANDSCAPE ARCHITECT PRIOR TO INSTALLATION.


4. ALL NEW PLANT BED AREAS TO BE IRRIGATED. REFER TO SPECIFICATIONS FOR IRRIGATION SYSTEM DESCRIPTION.


5. IN THE EVENT OF WORK IN OR ON THE JCW SANITARY MAIN. ANY TREES OR PLANTINGS PLACED WITHIN THE SEWER EASEMENT MAY BE REMOVED WITHOUT REPLACEMENT OR COMPENSATION THERE OF AND SHALL BE REPLACED BY THE PROPERTY OWNER AS REQUIRED BY THE CITY.

6. STRIP TOP SOIL & SAVE FOR PLANTING AREAS. EXCAVATE TO A DEPTH OF 18" FOR ALL PLANTING BEDS AND REPLACE WITH PLANTING SOIL MIX.. REFER TO L3.00 FOR PLANTING SOIL MIX.

7. ALL MECHANICAL EQUIPMENT WILL BE SCREENED PER UDO REQUIREMENTS.




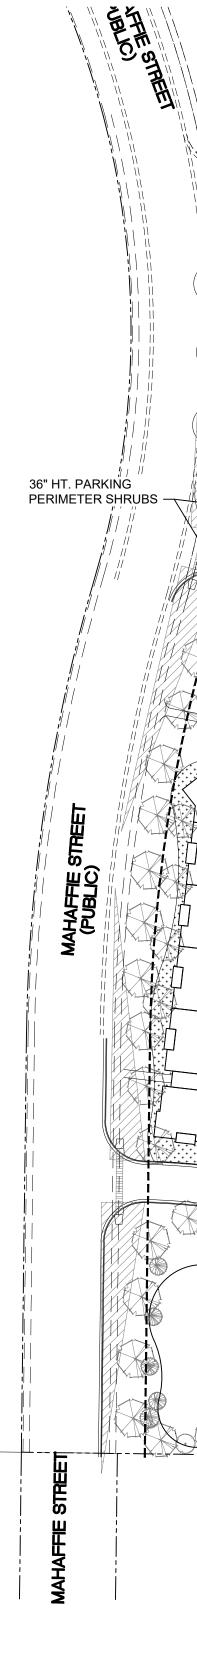


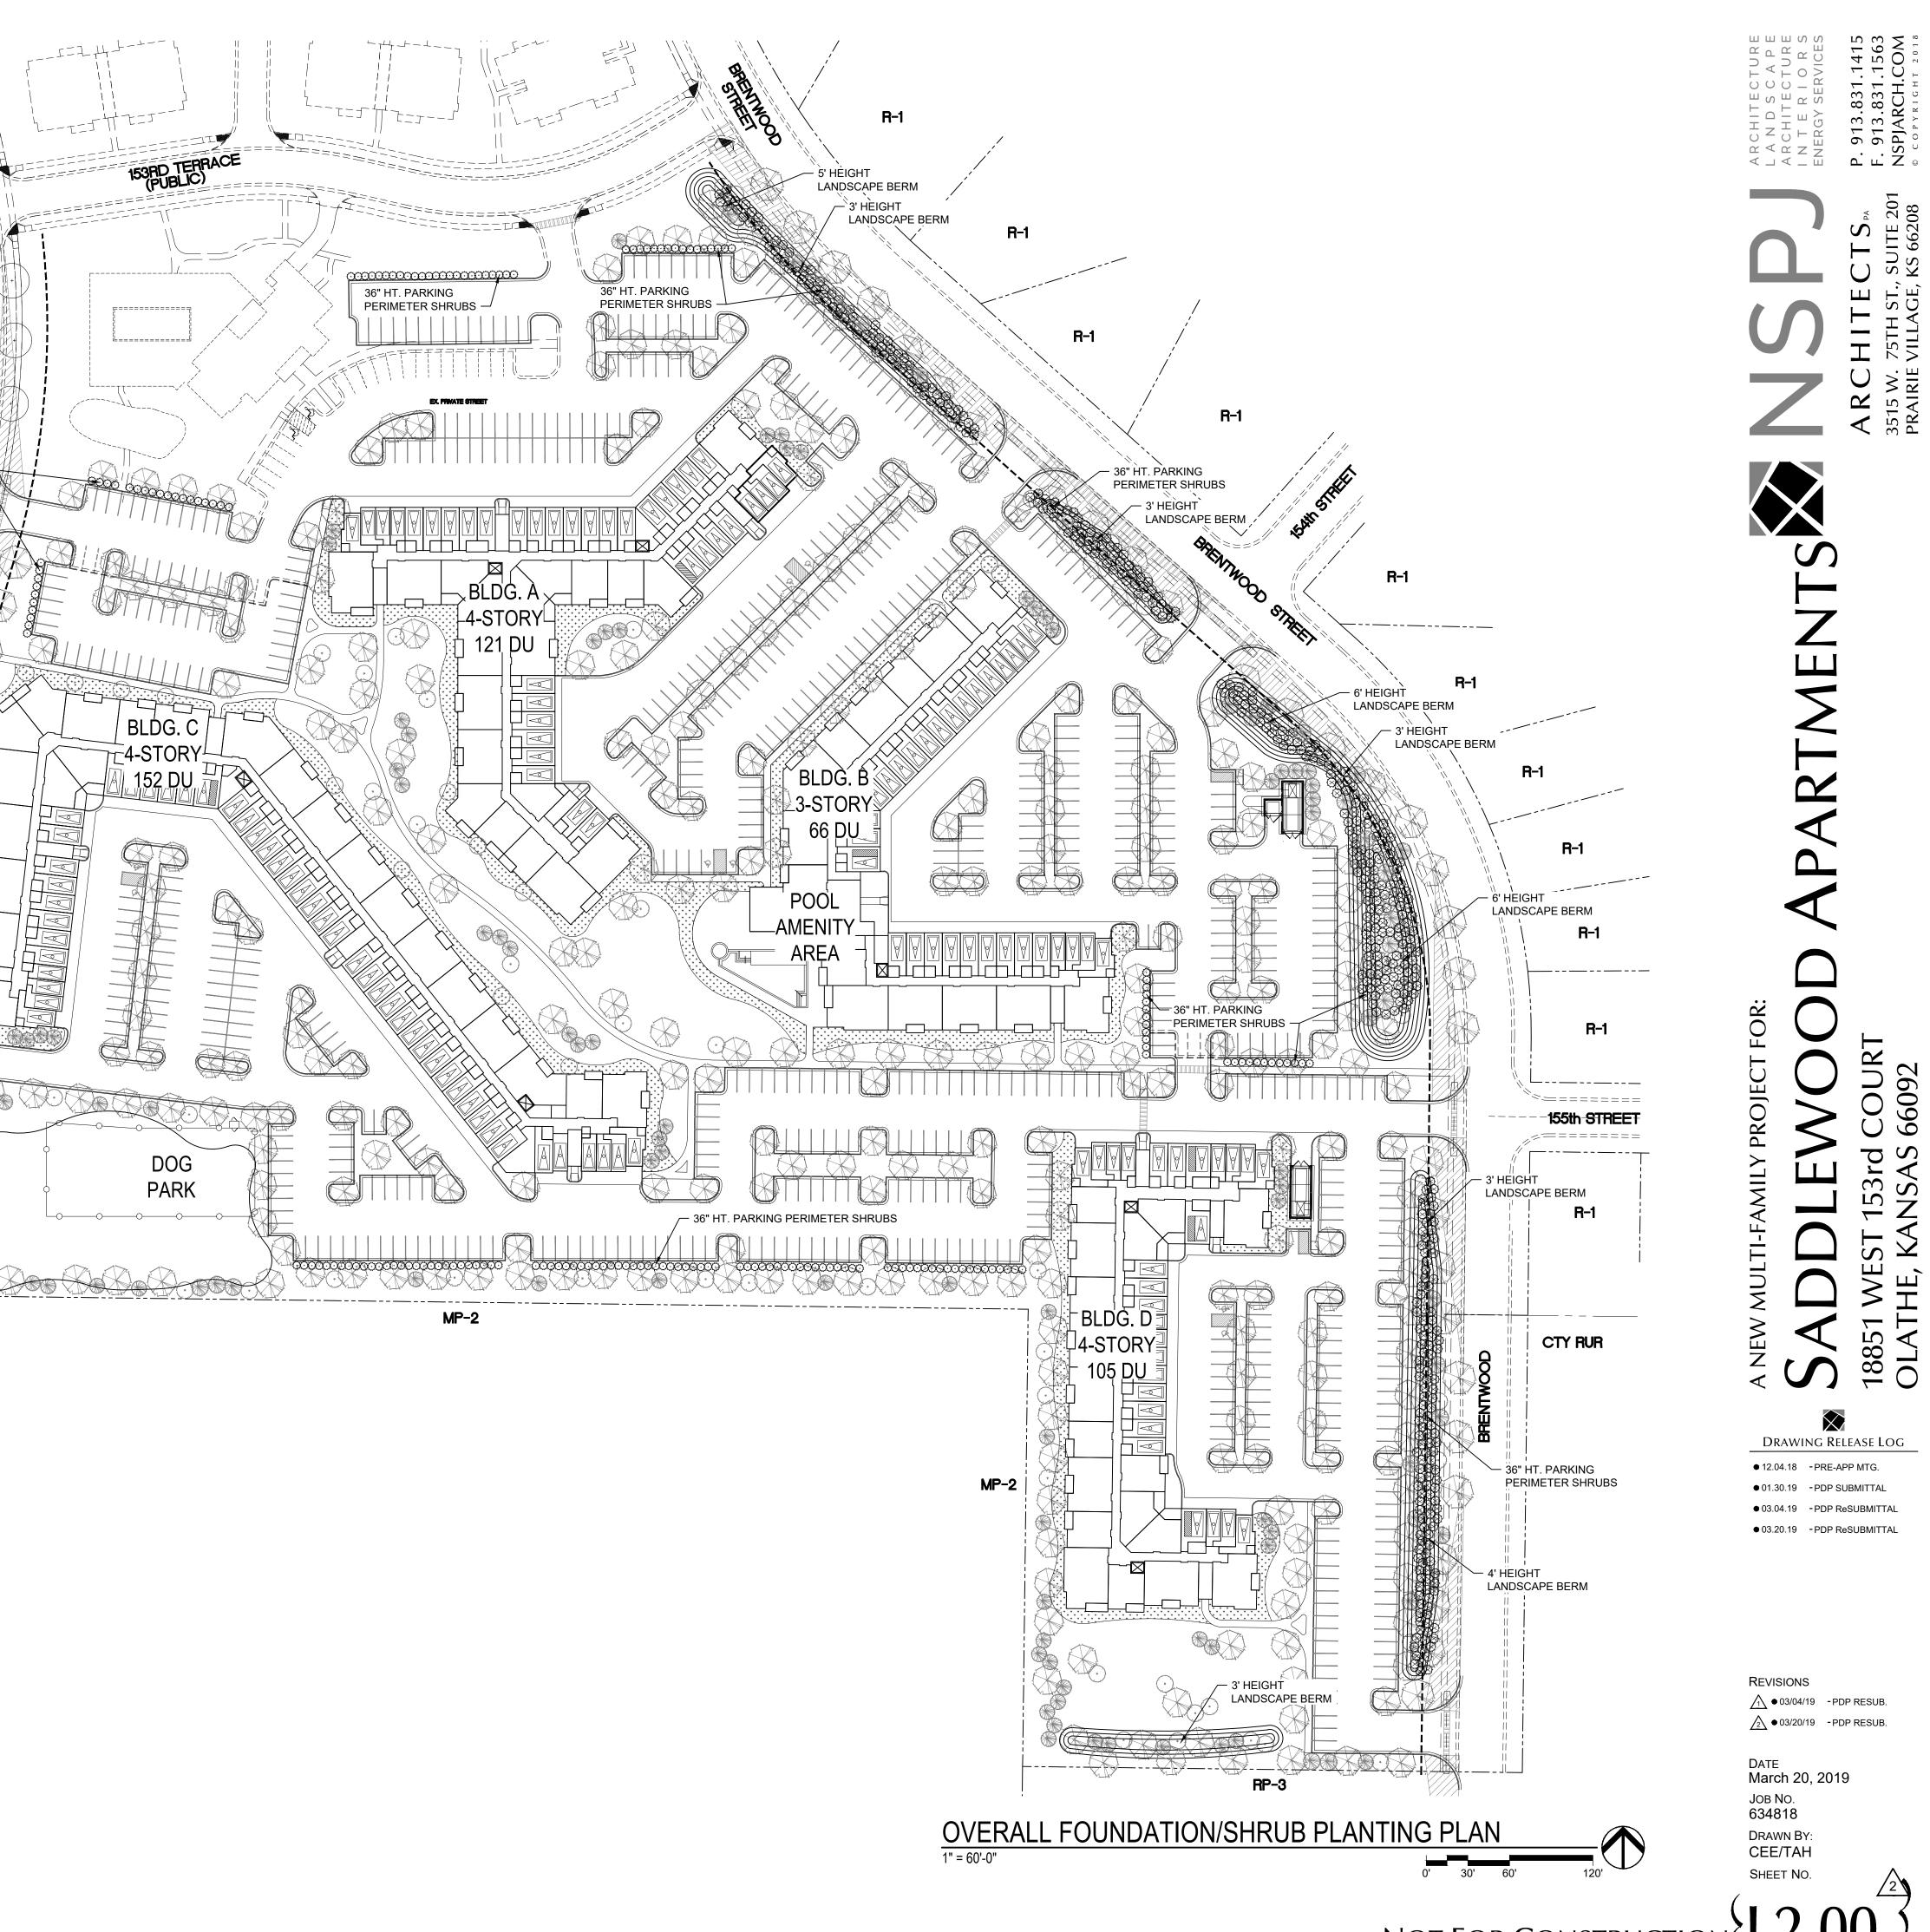

NOT FOR CONSTRUCTION  $L_2$ 

<sup>+</sup> 0.3	<sup>+</sup> 0.2	<sup>+</sup> 0.2	<sup>+</sup> 0.2	+0.3	+0.3	+0.2	+0.2	+0.2	<sup>+</sup> 0.1	<sup>+</sup> 0.						
<sup>+</sup> 0.6	<sup>+</sup> 0.5	+0.4	<sup>+</sup> 0.5	<sup>+</sup> 0.5	<sup>+</sup> 0.5	<sup>+</sup> 0.5	<sup>+</sup> 0.4	° <sup>+</sup> 0.2	°0.1	+0.1			///			4
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+1.5	+1.6	<sup>+</sup> 1.8			$\overline{\mathbf{x}}$		<sup>+</sup> 1.7	+1.1	<sup>+</sup> 0.4	<sup>+</sup> 0.3	+0.5	+0.9	<sup>+</sup> 1.6		<sup>+</sup> 3.7	<sup>+</sup> 2.
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+1.0	1.7	<sup>+</sup> 2.1	+3.1	<b>*</b> 5.0	<b>°</b> 5.4	°4.8	°2.7	°1.9	°1.6	°1.5	°1.8	°2.2	<b>3</b> .4	°5.1	<b>°</b> 5.4	°4.
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DRAWING RELEASE LOG

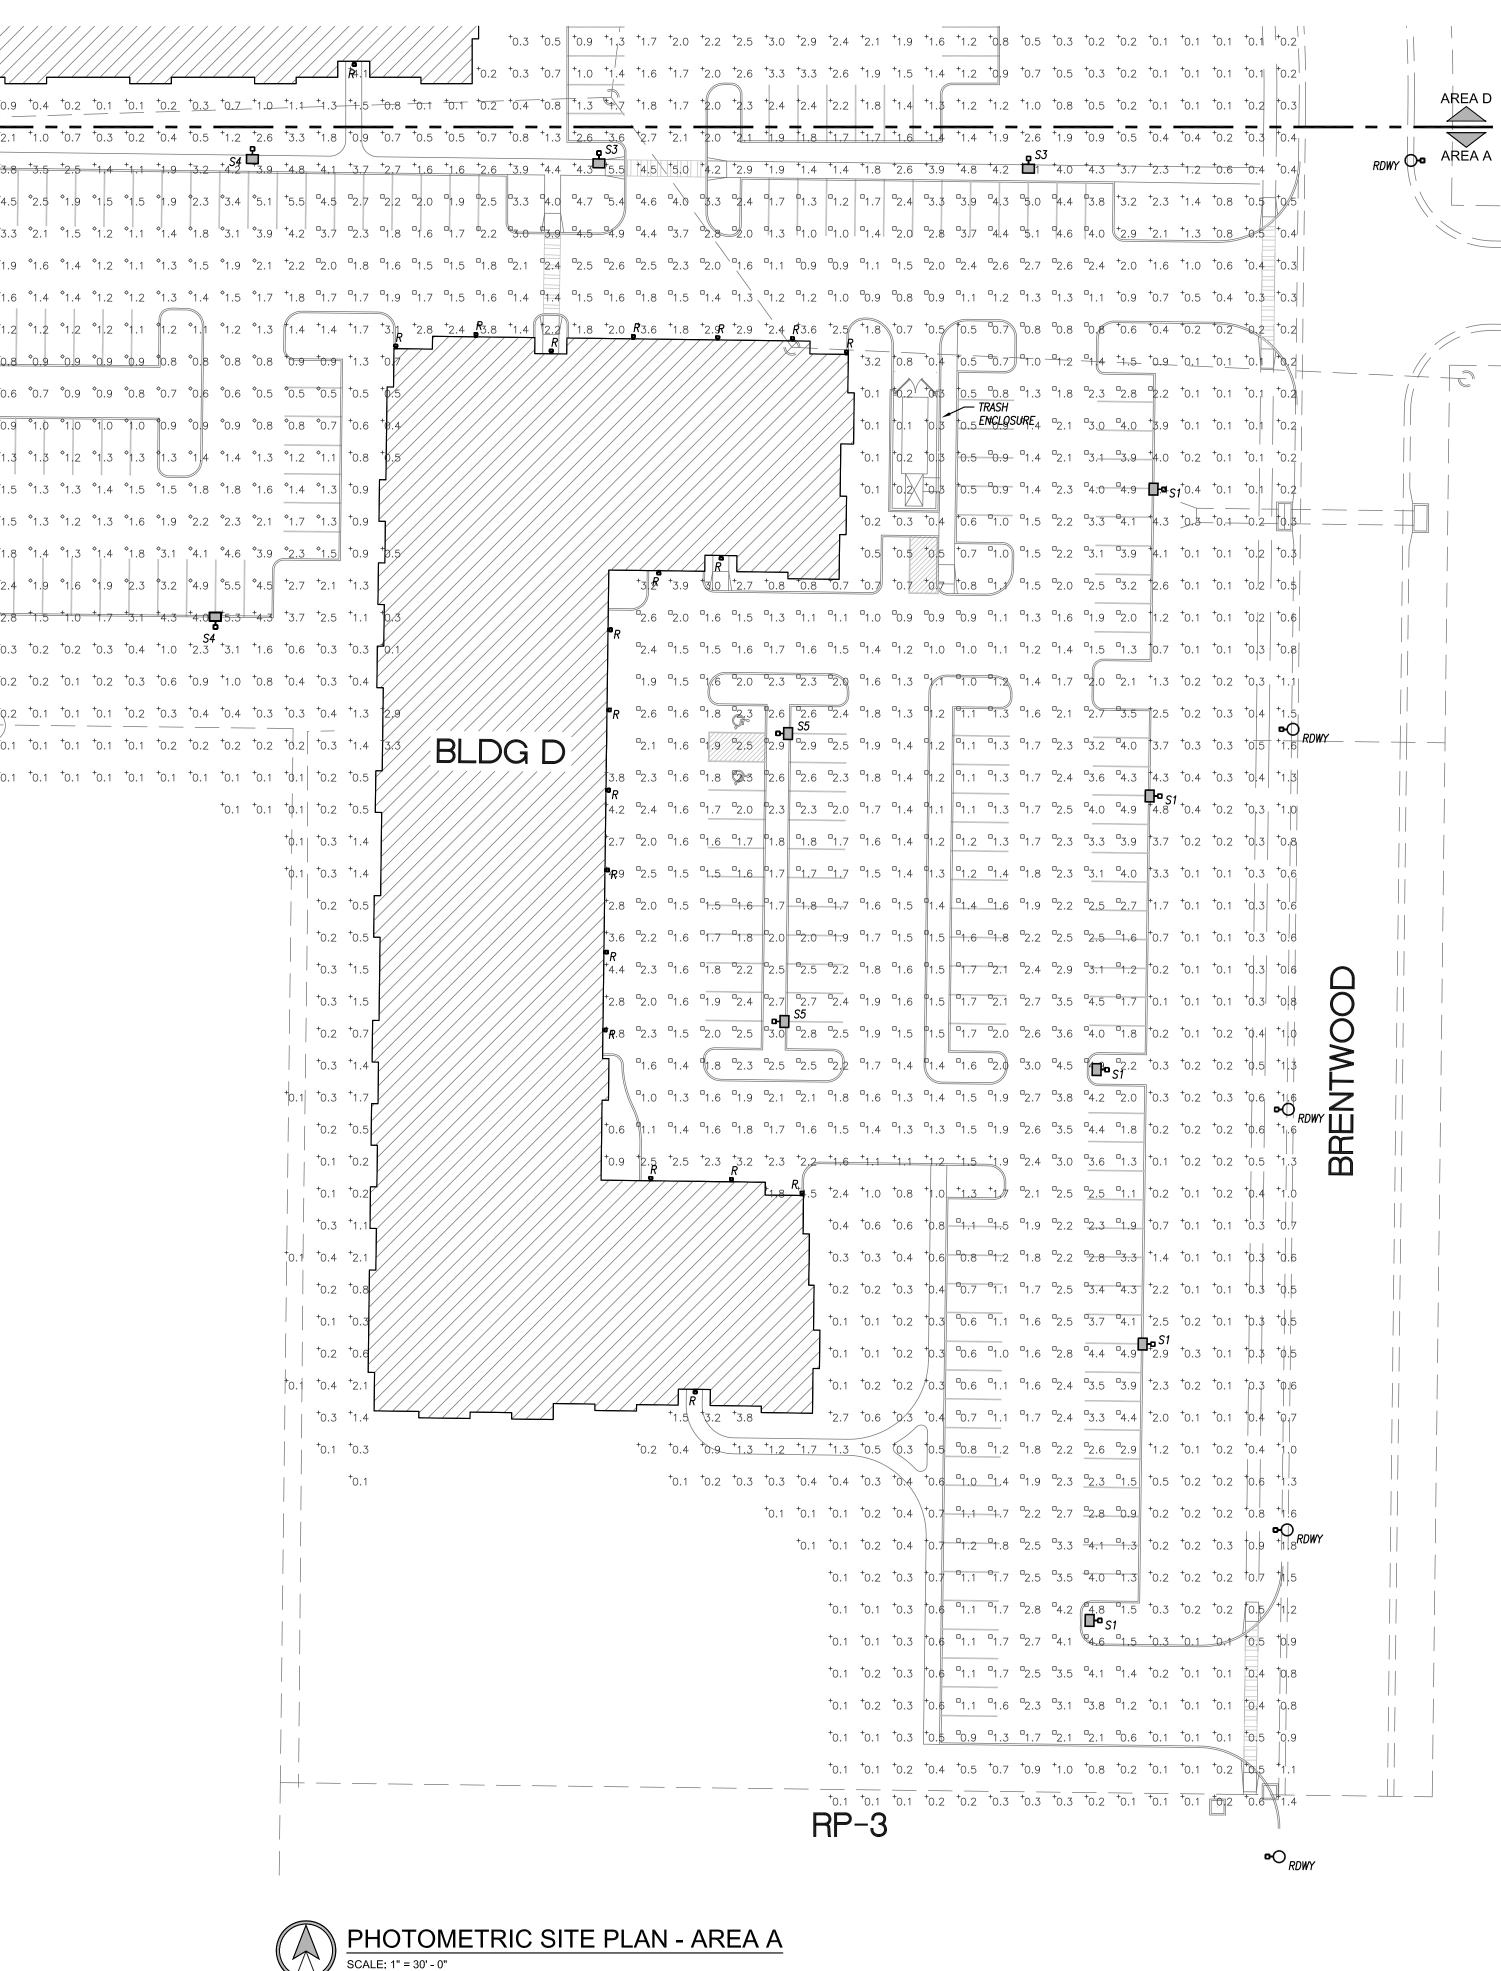12.04.18 - PRE-APP MTG.
01.31.19 - DRAWING RELEASE

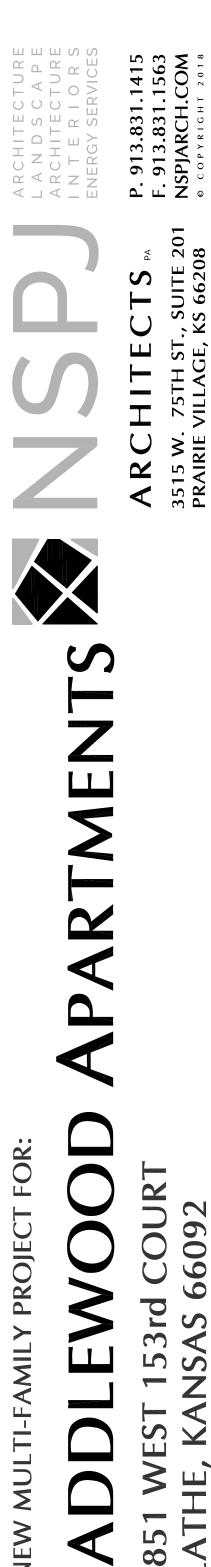18 OL



REVISIONS 1 03.04.19 - PDP RESUB 2 03.20.19 - PDP RESUB

DATE March 20, 2019 JOB NO. 634818 DRAWN BY: RKN SHEET NO. EIIOI



+10 *1.3 *1.6 *2.2 *4.5 *2.8 *2.1 *2.3 *2.6 *2.6 *2.7 *2.8 *2.5 *3.2 *3.8 *2.8 *3.0 *2.6 *1.9 *1.4 *1.7 *3.1 *3.4 *2.5 *1.3 *0.7 *0.2 *0.1 *0.9 *1.1 *1.2 *1.4 *2.1 *4.1 *2.2 *1.8 *1.8 *2.2 *2.4 *2.2 *2.4 *2.2 *2.4 *2.2 *3.4 *3.5 *2.2 *2.4 *2.3 *17 *1.2 *0.9 *0.9 *0.9 *0.7 *0.4 *0.2 *0.1
*0.7 *0.8 *1.0 *1.1 *1.9 *2.5 *1/7 *1.6 *1.7 *2.0 *2.1 *1.8 *1.7 *2.0 *4.2 *3.2 *1.9 *1.7 *1.7 *1.5 *1.0 *0.6 *0.4 *0.3 *0.2 *0.1 *0.1
+0.4 +0.5 +0.7 +1.0 +1.2 +1.1 +1.2 +1.4 +1.6 +1.7 +1.6 +1.5 +1.8 +3.6 +2.5 +1.6 +1.4 +1.3 +1.1 +0.7 +0.3 +0.2 +0.1 +0.1
$\begin{array}{c} +0.3 \\ +0.4 \\ +0.4 \\ +0.4 \\ +0.4 \\ +0.4 \\ +0.4 \\ +0.4 \\ +0.5 \\ +0.7 \\ +0.8 \\ +1.0 \\ +1.1 \\ +1.2 \\ +1.2 \\ +1.2 \\ +1.2 \\ +1.3 \\ +1.3 \\ +1.3 \\ +1.3 \\ +1.3 \\ +1.3 \\ +1.3 \\ +1.3 \\ +1.3 \\ +1.3 \\ +1.3 \\ +0.6 \\ +0.3 \\ +0.2 \\ +0.1 \\ +0$
$\frac{1}{1.2} \frac{1}{1.2} \frac{1}{1.2} \frac{1}{1.2} \frac{1}{1.2} \frac{1}{1.2} \frac{1}{1.2} \frac{1}{1.3} \frac{1}{1.1} \frac{1}{1.5} \frac{1}$
*0.4 *0.6 *0.7 *0.9 *0.9 *0.9 *0.7 *0.4 *0.2 *0.1 *0.1
<sup>+</sup> 0.4 <sup>+</sup> 0.4 <sup>+</sup> 0.6 <sup>+</sup> 0.9 <b>•</b> 1.3 <sup>+</sup> 1.0 <sup>+</sup> 0.8 <sup>+</sup> 0.7 <sup>+</sup> 0.4 <sup>+</sup> 0.2 <sup>+</sup> 0.1 <sup>+</sup> 0.1
*0.3 *0.4 *0.5 *0.9 *1.1 *1.6 *1.5 *1.0 *0.5 *0.2 *0.1 *0.2 *0.3 *0.5 *0.7 *1.1 *1.5 *1.3 *0.7 *0.4 *0.2
0.2 0.3 0.3 0.7 1.1 1.3 1.3 0.7 0.4 0.2 t0.1 t0.2 t0.4 t0.6 t1.0 t1.3 t1.1 t0.7 t0.4 t0.2 t0.1 t0.2 t0.4 t0.6 t1.0 t1.3 t1.1 t0.7 t0.4 t0.2
*0.2 *0.3 *0.7 *1.3 *1.5 *1.0 *0.6 *0.4 *0.2
$\begin{array}{c} + 1.1 & + 2.7 \\ + 3.8 & + 2.3 & + 4 \\ R 6 & + 3.2 \\ R \\ $
2.7 °1.7 °1.6 °1.7 °1.7 °2.3 °2.1 °2.2 °2.9 °2.0 °35 *0.3 °0.6 °1.1 °1.4 °0.9 °0.5 °0.3 *0.3 °0.7 °0.4 °0.7 °0.7 °0.4 °0.7 °0.
PT 4 °1.8 °1.4 °1.7 °2.0 °2.2 °2.1 °1.9 °1.7 °1.6 °1.7 +2.4 \$1.0 °1.7 °1.6 °1.7 +2.4
*0.3 *0.6 *0.8 *1.5 *0.7 *0.5 *0.3 *0.2 *1.0 *1.6 *1.6 *2.2 *3.9
$\begin{array}{c} & & & & & & & & & & & & & & & & & & &$
3.3 1.8 1.7 2.1 21 2.9 2.7 2.3 2.2 1.9 1.8 2.0 3.3 39 +2.4 °1.7 °1.7 °2.1 °2.5 °2.7 °2.8 °2.6 °2.4 °2.5 °
* * 3.1 °1.7 °1.6 °1.8 °2.0 2.3 °2.5 °2.6 °2.5 °2.6 °2.5 °2.6 °2.5 °2.6 °2.5 °2.6 °2.5 °2.6 °2.5 °2.6 °2.5 °2.6 °2.6 °2.6 °2.6 °2.6 °2.6 °2.6 °2.6
<sup>6</sup> 2.1 °1.6 °1.5 °1.7 °1.9 °2.1 °2.3 °2.4 °2.6 °2.9 °3.1 °2.3 °2.4 °2.6 °2.9 °3.1 °2.3 °2.4 °2.6 °2.9 °3.1 °2.3 °5.2 °2.1 °2.1 °2.1 °2.1 °2.1 °2.1 °2.1 °2
t 1 2.2 °1.6 °1.6 °1.7 °1.9 °2.1 °2.2 °2.4 °2.6 °2.9 °3.1 °3.2 °2.8 °2.4 °1.8 °1.7 °2.6 *3.0 ↑ 0.3 °0.5 °0.7 °0.9 °1.3 °1.1 °0.5 °0.4 ~0.3 °0.2 °0.1 °0.1 °0.1 °0.1 °0.1 °0.1 °0.1 °0.1
<sup>+</sup> 3.1 °1.9 °1.7 °2.0 °2.4 °2.6 °2.5 °2.4 °2.4 °2.3 °2.3 °2.2 °2.1 °1.9 °1.7 °1.4 °1.3 °1.5 <sup>+</sup> 2.3
P + 4.3 ℃ °1.8 °2.3 °2.7 °2.8 °2.5 °2.2 °2.0 °1.9 °1.8 °1.7 °1.7 °1.7 °1.7 °1.7 °1.7 °1.7 °1.7
<sup>+</sup> 2.0 °1.6 °1.8 °2.5 °3.0 °2.6 °2.0 °1.8 °1.7 °1.6 °1.5 °1.6 °1.7 °1.8 °1.7 °1.8 °1.5 °1.5 °1.5 °1.5 °1.5 °1.5 °1.5 °1.5
1.3 1.6 1.4 1.7 2.3 2.8 1.0 2.5 2.3 2.0 1.8 1.5 1.5 1.5 1.5 1.5 1.5 1.5 1.5 1.5 1.5
+1.7 +2.2 +3.3 +2.5 *2.0 *1.9 *1.8 *2.1 *2.4 *2.7 *2.7 *2.7 *2.5 *2.4 *2.4 *2.3 *2.3 *2.5 *2.6 *2.7 *2.8 *2.8 *2.7 *2.2 *1.7 *1.5 *1.7 +3.6
$\begin{array}{c} & & & & \\ & & & & \\ & &$
<sup>+4.3</sup> <sup>+5.2</sup> <sup>+5.3</sup> <sup>+6.6</sup> <sup>+3.6</sup> <sup>+0.1</sup> <sup>+</sup>
S3 5 +3.7 +4.7 +4.1 +4.4 +4.0 +2.9 +1.7 +1.2 +1.4 +2.2 +2.7 *3.5 +4.9 *5.7 +4.9 *3.4 *3.0 *3.0 *2.8 *2.6 *2.7 *2.7 *2.6 *2.5 *2.2 *1.9 *1.6 *1.6 *1.8 +3.5
<sup>+</sup> 1.0 <sup>+</sup> 1.6 <sup>+</sup> 1.4 <sup>+</sup> 0.8 <sup>+</sup> 0.7 <sup>+</sup> 0.8 <sup>+</sup> 0.7 <sup>+</sup> 1.6 <sup>+</sup> 3.0 <sup>+</sup> 4.4 <sup>+</sup> 4.5 <sup>+</sup> 6.0 <sup>+</sup> 4.9 <sup>+</sup> 4.2 <sup>+</sup> 3.2 <sup>+</sup> 3.5 <sup>+</sup> 3.2 <sup>+</sup> 2.7 <sup>0</sup> 2.7 <sup>0</sup> 2.8 <sup>2.9 <sup>0</sup>2.7 <sup>0</sup>2.5 <sup>0</sup>2.3 <sup>2.1 <sup>0</sup>1.9 <sup>0</sup>1.9 <sup>0</sup>1.9 <sup>0</sup>2.0 <sup>+</sup>2.3 <sup>1.1 <sup>0</sup>1.4 <sup>0</sup>1.7 <sup>0</sup>2.0 <sup>0</sup>2.2 <sup>0</sup>1.9 <sup>0</sup></sup></sup></sup></sup></sup></sup></sup></sup></sup></sup></sup></sup></sup></sup></sup></sup></sup></sup></sup></sup></sup></sup></sup></sup></sup></sup></sup></sup></sup></sup></sup></sup></sup></sup></sup></sup></sup></sup></sup>
<sup>+</sup> 0.5 <sup>+</sup> 0.6 <sup>+</sup> 0.6 <sup>+</sup> 0.4 <sup>+</sup> 0.2 <sup>+</sup> 0.2 <sup>+</sup> 0.1 <sup>+</sup> 0.2 <sup>+</sup> 0.2 <sup>+</sup> 0.3 <sup>+</sup> 0.4 <sup>+</sup> 1.0 <sup>+</sup> 2.2 <sup>+</sup> 3.1 <sup>+</sup> 1.8 <sup>+</sup> 11 <sup>+</sup> 1.0 <sup>+</sup> 3.8 <sup>+</sup> 3.2 <sup>+</sup> 2.9 <sup>+</sup> 2.8 <sup>+</sup> 2.8 <sup>+</sup> 2.7 <sup>+</sup> 2.7 <sup>+</sup> 2.7 <sup>+</sup> 2.7 <sup>+</sup> 2.6 <sup>+</sup> 2.4 <sup>+</sup> 1.9 <sup>+</sup> 1.6 <sup>+</sup> 1.9 <sup>+</sup> 1.2 <sup>+</sup> 1.1 <sup>+</sup> 1.4 <sup>+</sup>
*0.1 *0.1 *0.1 *0.1 *0.1 *0.1 *0.1 *0.1
$^{+}0.1$ $^{+}0.1$ $^{+}0.1$ $^{+}0.1$ $^{+}0.1$ $^{+}0.1$ $^{+}0.1$ $^{+}0.1$ $^{+}0.2$ $^{+}0.2$ $^{+}0.2$ $^{+}0.3$ $^{+}0.6$ $^{+}1.2$ $^{+}3.2$ $^{+}5.9$ $^{+}5.5$ $^{+}3.3$ $^{+}3.1$ $^{+}2.9$ $^{+}2.8$ $^{+}2.3$ $^{+}1.1$ $^{+}$
$\begin{array}{c} \bullet 0.1  \bullet 0.2  \bullet 0.2  \bullet 0.3  \bullet 0.5  \bullet 0.9  \bullet 1.7  \bullet 5.1  \bullet 3.4  \bullet 3.1  \bullet 3.2  \bullet 3.0  \bullet 2.7  \bullet 2.7 $
<sup>+</sup> 0.1 <sup>+</sup> 0.1 <sup>+</sup> 0.1 <sup>+</sup> 0.2 <sup>+</sup> 0.2 <sup>+</sup> 0.2 <sup>+</sup> 0.3 <sup>+</sup> 0.4 <sup>+</sup> 2.7 <sup>+</sup> 3.0 <sup>+</sup> 2.8 <sup>+</sup> 3.0 <sup>+</sup> 3.3 <sup>+</sup> 3.5 <sup>+</sup> 3.2 <sup>+</sup> 2.7 <sup>+</sup> 2.5 <sup>+</sup> 2.4 <sup>+</sup> 2.4 <sup>+</sup> 2.3 <sup>+</sup> 2.1 <sup>+</sup> 2.2 <sup>+</sup> 2.1 <sup>+</sup> 1.8 <sup>+</sup> 1.6 <sup>+</sup> 1.5 <sup>+</sup> 1.3 <sup>+</sup> 1.4 <sup>+</sup> 1.5 <sup>+</sup> 1.7 <sup>+</sup> 2.0 <sup>+</sup> 2.0 <sup>+</sup> 1.4 <sup>+</sup> 1.4 <sup>+</sup> 1.5 <sup>+</sup> 1.5 <sup>+</sup> 1.7 <sup>+</sup> 2.0 <sup>+</sup> 1.8 <sup>+</sup> 1.6
<sup>+</sup> 0.1 <sup>+</sup> 0.1 <sup>+</sup> 0.1 <sup>+</sup> 0.1 <sup>+</sup> 0.2 <sup>+</sup> 0.7 <sup>+</sup> 1.4 <sup>+</sup> 1.9 <sup>+</sup> 2.5 <sup>+</sup> 4.2 <sup>+</sup> 5.3 <sup>+</sup> 5.5 <sup>+</sup> 4.7 <sup>+</sup> 2.7 <sup>+</sup> 2.2 <sup>+</sup> 2.0 <sup>+</sup> 2.0 <sup>+</sup> 2.4 <sup>+</sup> 3.9 <sup>+</sup> 4.8 <sup>+</sup> 5.0 <sup>+</sup> 4.3 <sup>+</sup> 2.7 <sup>+</sup> 1.5 <sup>+</sup> 2.1 <sup>+</sup> 3.9 <sup>+</sup> 4.8 <sup>+</sup> 4.0 <sup>+</sup> 2.2 <sup>+</sup> 1.6 <sup>+</sup> 1.3 <sup>+</sup> 1.5 <sup>+</sup> 2.1 <sup>+</sup> 3.9 <sup>+</sup> 4.8 <sup>+</sup> 4.0 <sup>+</sup> 2.2 <sup>+</sup> 1.6 <sup>+</sup> 1.4 <sup>+</sup> 1.5 <sup>+</sup> 1.8 <sup>+</sup> 2.7 <sup>+</sup> 4.4 <sup>+</sup> 5.1 <sup>+</sup> 4.4 <sup>+</sup> 2.8 <sup>+</sup> 0.1 <sup>+</sup> 0.1 <sup>+</sup> 0.1 <sup>+</sup> 0.1 <sup>+</sup> 0.1 <sup>+</sup> 0.1 <sup>+</sup> 0.2 <sup>+</sup> 0.5 <sup>+</sup> 1.2 <sup>+</sup> 2.3 <sup>+</sup> 2.3 <sup>+</sup> 2.8 <sup>+</sup> 2.4 <sup>+</sup> 2.6 <sup>+</sup> 2.9 <sup>+</sup> 3.6 <sup>+</sup> 4.6 <sup>+</sup> 4.7 <sup>+</sup> 4.0 <sup>+</sup> 2.8 <sup>+</sup> 2.4 <sup>+</sup> 1.6 <sup>+</sup> 1.5 <sup>+</sup> 2.2 <sup>+</sup> 2.7 <sup>+</sup> 3.6 <sup>+</sup> 4.6 <sup>+</sup> 3.8 <sup>+</sup> 2.7 <sup>+</sup> 2.3 <sup>+</sup> 1.8 <sup>+</sup> 2.0 <sup>+</sup> 2.5 <sup>+</sup> 3.0 <sup>+</sup> 4.4 <sup>+</sup> 5.6 <sup>+</sup> 4.4 <sup>+</sup> 3.1
$\begin{array}{c} \bullet \bullet$
34     34     34     34       *0.1     *0.1     *0.2     *0.3     *0.5     *1.1     *2.2     *2.4     *1.3     *0.6     *0.3     *0.5     *1.1     *2.2     *2.5     *1.3     *0.6     *0.2     *0.2     *0.2     *0.4     *1.1     *2.2     *2.3     *1.1     *0.4     *0.2 </th
$\begin{array}{c} & & & & & & & & & & & & & & & & & & &$
AR

PHOTOMETRIC SITE PLAN - AREA B  $\mathcal{A}$ SCALE: 1" = 30'-0"

 $\overset{\mathsf{C}}{=}\overset{\mathsf{$ I 3.831.14 I 3.831.15 ARCH.CO 000 – P. 9 9 F. 9 <sup>1</sup> NSP  $\triangleleft \dashv \triangleleft \_$ CTS MACCTS MACCT S . 75TH ST. VILLAGE, -I ARC| 3515 W. PRAIRIE V S FOR 4 COUF 66092 N S  $\mathbf{n}$ S S Ζ S X 3 ATHE, NM NEW S 188. OLA S

 $\mathbf{X}$ DRAWING RELEASE LOG • 12.04.18 - PRE-APP MTG. • 01.31.19 - DRAWING RELEASE

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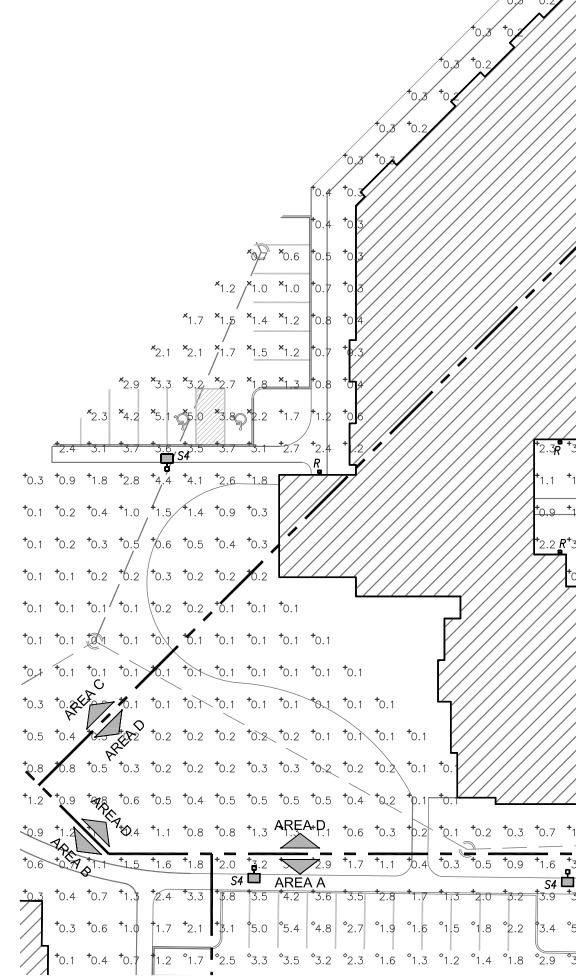


REVISIONS 1 03.04.19 - PDP RESUB 2 03.20.19 - PDP RESUB

DATE March 20, 2019 JOB NO. 634818 DRAWN BY: RKN SHEET NO.

\*0.1 \*<del>0.2</del> \*<del>0</del>.3 \*0.6 \*0.8 \*1.1 ,\*1.4 \\*0.8 \\*0.2 \*0.2 \*0.1 \*0.1 \*0.  $\begin{array}{c} \mathbf{f}_{0,1} & \mathbf{f}_{0,2} \\ \mathbf{f}_{1,0} & \mathbf{f}_{1,0} \\ \mathbf{f}_{1,0} & \mathbf{f}_{1,2} \\ \mathbf{f}_{1,3} & \mathbf{f}_{1,3} & \mathbf{f}_{1,3} & \mathbf{f}_{0,1} \\ \mathbf{f}_{0,1} & \mathbf{f}_{0,1} \\ \mathbf{f}_{0,1} & \mathbf{f}_{0,2} \\ \mathbf{f}_{0,2} & \mathbf{f}_{0,3} \\ \mathbf{f}_{0,1} & \mathbf{f}_{0,1} \\ \mathbf{f}_{0,1} & \mathbf{f}_{0,2} \\ \mathbf{f}_{0,2} & \mathbf{f}_{0,3} \\ \mathbf{f}_{0,3} \mathbf{f}_{0,3}$ +0.1 +0.1 +0.2 +0.3 +0.5 +0.6 +0.6 +0.3 +0.1 +0.1\*0.1\_+0.1\_+0.1 +0.1 \*0.2 \*0.3 +0.3 \*0.2 \*0.2 \*0.2 \*0.2 \*0.2 \*0.1 \*0.1 **1** +0.1 +0.1 +0.1 +0.1 +0.1 +0.1 +0.1 +0.1 +0.2 +0.3 +0.4 +0.5 +0.5 +0.3 +0.1 +0.1 +0.1 +0.2 +0.3 +0.4 +0.4 +0.5 +0 <sup>+</sup>0.1 <sup>+</sup>0.1 <sup>+</sup>0.1 <sup>+</sup>0.1 <sup>+</sup>0.1 <sup>+</sup>0.1 <sup>+</sup>0.1 +0.1 +0.1 +0.2 +0.3 +0.3 +0.3 +0.3 +0.1 +0.1 +0.3 | +φ.1 +0.2 +0.2 +0.3 +0.3 +φ.2 +0.1 +d.1 +0.1 +0.2 +0.2 +0.2 +d.2 +0.1 +0.1 +0.1 +0.2 +0.2 +0.2 +0.1 **+**0.1 **+**0.1 ·o|1 td.1 to.**↓** ·0.2 to.2 to.2 to.2 to.1 \*0.1 \*0.3 \*0.3 +0.1 d.1 +0.2 +0.2 +0.2 +0.2 +0.1 \*0.1 \*0.4 \*2.0 \*1.6 POOL +0.1 +0.6 +4.1 **|**+0.1 **†**0.2 **+**0.3 **+**0.3 **+**0.2 **+**0.1 **†** +0.1 +0.1 +0.2 +0.3 +0.4 +0.4 +0.3 +0.1 EXISTING <sup>+</sup>0.1 <sup>+</sup>0.1 BLDG +0.1 +0.1 +0.2 +0.3 +0.5 +0.5 +0.4 +0.1 +0.1 **\***0.1 **\***0.3 **\***0,6 =\_\_\_\_<sup>+</sup>0.1 <sup>+</sup>0.2 <sup>+</sup>1.2 <sup>↓</sup>  $04^{+}0.6^{+}0.6^{+}0.5^{+}0.2^{+}0.1^{+}0.1$ ± +0.7 +0,9 +0.6 +0.2 +0.1 /10.1 +0.1 +0.1 -**\***0.2 **\***1.1 **\***3.7 5 +0.2 +0.3 +0.6 +1.3 +Q .5 🖅 <sup>+</sup>0.9 <sup>+</sup>1.2 <sup>†</sup>0,7 <sup>†</sup>0.2 <sup>+</sup>0.1///<sup>+</sup>0.1 <sup>+</sup>0.1 <sup>+</sup>0.1 <sup>+</sup>0.1 //+0/1 +0.1 +0.2 +0.3 +0.4 / +0.4 **\***3.7 **\***3.2 **\***1.7 **\***1.6 **\***1.7 <sup>\*</sup>1.9 **\***1.7 **\***1.5 **\***1.6 **\***2.2 **\***2.**# \***2.1 **\***2.0 **\***2.0 **\***1.6 /**\***1. \*0.1 <sup>+</sup>0.1 <sup>+</sup>0.2 <sup>+</sup>0.3 <sup>+</sup>0.3 <sup>+</sup>0.3 #0.1 <sup>+</sup>0.1 <sup>+</sup>0.2 <sup>+</sup>0.2 <sup>+</sup>0.2 <sup>+</sup>0.2 <sup>+</sup>0.2 <sup>+</sup>0.4 <sup>+</sup>0.8 <sup>+</sup>1.4 <sup>\*</sup>2.1 <sup>\*</sup>3.0 <sup>\*</sup>2.9 <sup>\*</sup>3.8 <sup>\*</sup>4.2 <sup>\*</sup>3.0 <sup>\*</sup>2.8 <sup>\*</sup>2.9 <sup>\*</sup>2.8 <sup>\*</sup>2.7 <sup>\*</sup>2.7 <sup>\*</sup>2.4 <sup>\*</sup>2.3 <sup>\*</sup>3.8 <sup>\*</sup>3.4 <sup>\*</sup>2.1 <sup>\*</sup>1.8 <sup>\*</sup>1.7 <sup>\*</sup>1.5 | + 0.1 + 0.1 + 0.2 + 0.2 + 0.2 + 0.2 + 0.2 + 0.2 + 0.5 + 0.9 + 1.5 × 2.2 × 3.1 × 3.0 × 4 0 5 × 3.4 × 3.5 × 3.2 × 2.9 × 2.9 × 3.1 × 2.9 × 2.7 × 3.6 × 2.9 × 2.3 × 2.2 × 1.9 × 1.5 0.1 +0.1 +0.2 +0.2 +0.2 +0.2 +0.2 +0.2 +0.2 +0.3 +0.5 +1.0 ×1.5 ×2.2 ×2.6 ×2.5 ×1.8 ×1.3 ×2.9 ×3.5 ×3.2 ×2.9 ×2.9 ×3.4 ×3.4 ×4.0 ×4.9 ×3.7 ×2.7 ×2.7 ×2.1 +1 \*0.1 \*0.1 \*0.2 \*0.3 \*0.3 \*0.3 \*0.3 \*0.2 \*0.2 \*0.2 \*0.3 \*0.6 \*1 0 \*1.3 \*1.3 \*1.6 \*2.2 \*4.5 \*2.8 \*2.1 \*2.3 \*2.6 \*2.6 \*2.7 \*2.8 \*2.5 \*3.2 \*3.8 \*2.8 \*3.0 \*2.6 \*1.9 \*1.4 \*1.7 \*3.1 \*3.4 \*2.5 \*1.3 \*0.7 \*0.2 \*0.1 + 0.2 + 0.3 + 0.4 + 0.4 + 0.3 + 0.2 + 0.2 + 0.2 + 0.3 + 0.6 + 0.9 + 1.1 + 1.2 + 1.4 + 2.1 + 4.1 + 2.2 + 1.8 + 1.8 + 2.2 + 2.4 + 2.2 + 2.1 + 2.2 + 3.4 + 3.5 + 2.2 + 2.4 + 2.3 + 1.7 + 1.2 + 0.9 + 0.9 + 0.7 + 0.4 + 0.2 + 0.1 ±0,3 <sup>+</sup>0.5 <sup>+</sup>0.7 <sup>+</sup>0.8 *|* <sup>\*</sup>1.0 <sup>\*</sup>1.1 <sup>\*</sup>1.9 <sup>\*</sup>2.5 <sup>\*</sup>1/7 <sup>\*</sup>1.6 <sup>\*</sup>1.7 <sup>\*</sup>2.0 <sup>\*</sup>2.1 <sup>\*</sup>1.8 <sup>\*</sup>1.7 <sup>\*</sup>2.0 <sup>\*</sup>4.2 <sup>\*</sup>3.2 <sup>\*</sup>1.9 <sup>\*</sup>1.7 <sup>\*</sup>*|*.5/<sup>+</sup>1.0 <sup>+</sup>0.6 <sup>+</sup>0.4 <sup>+</sup>0.3 <sup>+</sup>0.2 <sup>†</sup>0.1 <sup>+</sup>0.1 0.2 +0.3 +0.4 +0.5 +0.4 +0.2 +0.1/+0.2 +0.4 +0.5 +0.6/+0.8/+0.5 +0.2 +0.2 +0.2 +0.2 +0.2 +0.4 +0.4 +0.4 +0.5 +0.7 +0.8 +1.0 +1.1 +1.2 \*1.2 \*1.2 **\***1√.5 **\***2.1 **\***1.7 0.2 +0.3 +0.5 +0.7 +0.8//+1.1 +0.6 +0.2 +0.2 to.4 to.5 to.6 to.7 to.7 to.7 to.7 to.9 to.1 to.3 to.1 to.9 to.9 to.9 to.9 to.9 to.4 to.5 to.3 /to/2 to.2 to.1 to.1 +0.2 +0.4 +0.6 +1.0 +1./1/ +1/4/+0.6 +0.2/ +0.2 0.4<u>+</u>0.5 +0.6 +0.7 +0.8 \*p.3 \*0.4 \*0.8 \*RDWY\* 5 +1.d \*0.6 \*0.2 0.3 +0.4 +0.8 +1.0 +1.3 +1.5 +0.4 +0/3 +0. +0.2 +0.4 +0.6 +0.8 +1.2 +1.1 +0.3 +0.2 +c BLDG C +0.2 +0.3 +0.5 +0.7 /+0.9 +p.6 +0.2 +





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	*1.1 1.3 *1.5			
*0.7	*1.1 *1.1 *1.1 *1.1 *0.7 *0.8 *0.8 *0.8 *0.7			
Q.4 0.5	+0.7 +0.8 +0.8 +0.8 +0.7	SHE I		
	<b>*</b> 0.4 <sup>+</sup> 0.5 <sup>+</sup> 0.5 <sup>+</sup> 0.5 <sup>+</sup> 0.6			
	+0.2 +0.2 +0.2 +0.2 +0.3	0.4 $0.3$ $p$		
*1.6 *2.4 *3.6 *4.6 *2.5 *0.3				
	to 7 to 4 to 4 to 1		$\searrow$	
*0.8 *1.1 *1.5 *2.0 *2.6 *4.0 *4.8 *4.1	<sup>+</sup> 2.1 <sup>+</sup> 0.1 <sup>+</sup> 0.1 <sup>+</sup> 0.1	+0.2 +0.2 +0.2 +0.2 +0.2		
*0,5 *0,5 *0.8 *1.1 *1.4 *2.0 *3.0 *3.4 *3.8	*4.0 11.1 <sup>+</sup> 0.1 <sup>+</sup> 0.1 <sup>+</sup> 0.1	*@1 *0.2 *0.2 *0.2 *0.2 *0.7	<sup>+</sup> 0.3	
		+0.1 +0.1 +0.2 +0.2 +0.3 +0.3	$^{+0.3}$	
*0.7 (*1.2 *0.7 *1.1 *1.5 *1.9 <b>*</b> 2.0	<b>*</b> 1.8 <b>*</b> 1.1 <b>*</b> 0.6 <b>*</b> 0.5 <b>*</b> 0.1	+0.1 +0.1 +0.4 +0.2 +0.2 +0.3	+0.4 (10, +0.6 +0.8 // <	、 、
*0.5 *0.9 *3 *1.1 *1.4 *1.5	<b>*</b> 1.2 <b>*</b> 1.0 <b>*</b> 1.4 <b>*</b> 2.0 <b>*</b> 1.6	+0.1 +0.1 +0.1 +0.1 +0.1 +0.8	+0.3 +0.4 +0.6 +0.8 +1.2	
*0,3 *0 *1.3	<b>*</b> 1.1 <b>*</b> 1.4 <b>*</b> 2.1 <b>*</b> 3.2 <b>*</b> 4.6	$^{+}0.1$ $^{+}0.1$ $^{+}0.1$ $^{+}0.1$ $^{+}0.1$ $^{+}0.1$ $^{+}0.1$ $^{+}0.1$ $^{+}0.1$ $^{+}0.1$ $^{+}0.1$ $^{+}0.1$ $^{+}0.1$	+0.2 +0.3 +0.5 0.8 +1.1 +1 RDW	
(*0,3 *0.2)////////////////////////////////////	<b>*</b> 1.2 <b>*</b> 1.6 <b>*</b> 2.3 <b>*</b> 3.2 <b>*</b> 3.9	<sup>+</sup> 4/4 ↔ .3 <sup>+</sup> 0.3 <sup>+</sup> 0.1 <sup>+</sup> 0.1 <sup>+</sup> 0.1	<sup>*</sup> 0.2 <sup>+</sup> 0.3 <sup>+</sup> 0.5 <sup>+</sup> 0.8 <sup>*</sup> 1.	2 +1.3
*0.3 *0.2 *1.9 *1.2	<b>*</b> 1.3 <sup>+</sup> 1.6 <sup>+</sup> 2.1 <sup>+</sup> 2.7 <sup>+</sup> 3.	<sup>+</sup> 5.0 <sup>+</sup> 4.5 <sup>+</sup> 2.3 <sup>+</sup> 0.1 <sup>+</sup> 0.1 <sup>+</sup> 0.1	0.2 +0.2 +0.4 +0.5 +0.9 *	0 <sup>+</sup> 0.9 <sup>+</sup> 0.9
		<sup>+</sup> 3.8 <sup>+</sup> 3.9 <sup>+</sup> 4.6 <sup>+</sup> 1.4 <sup>+</sup> 0.1 <sup>+</sup> 0.1		
*4.3 *2.7 *1.9 *1.4 *1.2 R *3.2 *3.4 *2.0 *1.7 *7.5 *1.5				
<b>*A</b> <sup>4</sup> .6 <b>*</b> 2.4 <b>*</b> 2.1 <b>*</b> 2.1 <b>*</b> 2.1 <b>*</b> 2.2 <b>*</b> 2.0				
*2.5 *2.9 *1.9 *1.9 *2.3 *2.6 *2.6 *2.5				
<b>R</b> .7 *2.2 *1.6 *1.6 *2.0 *2.2 *2.8 = 3.1 *2.8				
*2.3 *2.4 *1.7 *1.4 *1.6 *2.9 *2.7 *2.9 *3.0 *2.9				
<b>*4</b> .8 *2.5 *1.5 *1.4 *1.5 *1.7 *2.1 *2.5 *2.8 *2.9 *2.8	<b>*</b> 2.5 <b>*</b> 2.4 <b>*</b> 2.4 <b>*</b> 2.3 <b>*</b> 2.3	<sup>+</sup> 2.3 <sup>+</sup> 2.3 <sup>+</sup> 2.2 <sup>+</sup> 1.9 <sup>+</sup> .6 <sup>+</sup> 1.4	<sup>+</sup> 1.2 <sup>+</sup> 1.1 <sup>+</sup> 1.0 <sup>+</sup> 0.9 <sup>+</sup> 0.9 <sup>+</sup> 0	.8 +0.6 +0.4 +0.3 +0.2 +0.2 +0.2
+2.7 +2.3 +1.8 +1.5 +1.6 +1.7 +2.0 +2.2 +2.3 +2.4 +2.5 +2.5	<b>*</b> 2.5 <b>*</b> 2.5 <b>*</b> 2.6 <b>*</b> 2.8 <b>3</b> .0	*3.1 *2.9 *2.7 *2.4 *2.2 *2.1	1.9 <sup>+</sup> 1.7 <sup>+</sup> 1.6 <sup>+</sup> 1.4 <sup>+</sup> 1.2 <sup>+</sup> 1	.1 *0.8 *0.5 *0.3 *0.2 *0.2 *0.2
<b>*************</b>	00_	11.		
+1.4 +1.9 +1.9 +1.9 +2.1 +2.4 +2.5 +2.5 +2.4 +2.3 +2.3 +2.2 +2.2 +2.2 +2.2 +2.3				
*2.5 $*1.6$ $*1.6$ $*2.1$ $*2.5$ $*2.8$ $*2.9$ $*2.8$ $*2.6$ $*2.5$ $*2.4$ $*2.3$ $*2.3$ $*2.3$ $*2.3$				
*4.2 *1.8 *1.6 *2.3 *2.2 *3.0 *2.6 *2.7 *2.7 *2.8 *2.7 *2.6			🗜 S2 // 💦 🕺	
<b>R</b> +4.0 +1.8 +1.6 +2.2 +2.7 +3.0 +3.1 +2.9 +2.6 +2.7 +3.0 +3.1 +3.0 +2.9 +2.0 +1.4 +1.4 +1.9 +2.4 +2.6 +2.7 +2.7 +2.5 +2.7 +2.7 +5.3 +3.3 +2.9				
<b>2 1</b> .8 <b>1</b> .2 <b>1</b> .3 <b>1</b> . <del>5 <b>1</b>.7 <b>1</b>.8 <b>1</b>.2 <b>1</b>.3 <b>1</b>.5 <b></b></del>				
$\begin{array}{c} \bullet \\ \bullet $				
*11_*0.9 *0.8 *0.9 *1.0 *1.1 *1.2 *1.4 *1.6 *1.8 *2.0 *2.1 *2.2 *2.1 *2.0		¥"		
<b><i>R</i></b> <sup>+</sup> 3.1 <sup>+</sup> 1.4 <sup>+</sup> 1.2 <sup>+</sup> 1.3 <sup>+</sup> 1.6 <sup>+</sup> 1.4 <sup>+</sup> 1.8 <sup>+</sup> 1.9 <sup>+</sup> 1.9 <sup>+</sup> 2.3 <sup>+</sup> 2.1 <sup>+</sup> 2.3 <sup>+</sup> 2.4 <sup>+</sup> 2.2	<b>*</b> 2.2 <b>*</b> 1.7 <b>*</b> 1.4 <b>*</b> 1.1 <b>*</b> 0.9	<sup>+</sup> 1.1 <sup>+</sup> 1.4 <sup>+</sup> 1 <sup>'</sup> .6 <sup>+</sup> 1.8 <sup>+</sup> 1.9 <sup>+</sup> 1.9	*1.9 *1.9 *1.9 *1.8 *1.7 *1	.5 +1.2 +0.8 +0.5 +0.3 +0.2 +0.1
+0.3 +1 2 + <b>R</b> 9 + 2 5 + 2 6 <b>C</b> 4 2 + 2 1 + 3 <b>C</b> + 3 4 + 2 7 <b>C</b> 8 + 2 8 + 3 8 + 4 5 + 3 6	<b>R</b> +4 6 *2.7 <b>R</b> 3.3 *1.7 *1.0	+1.0 +1.3 +1.6 +1.7 + <u>1.9 +2.0</u>	<sup>+</sup> 2.1 <sup>+</sup> 2.1 <sup>+</sup> 2.0 <sup>+</sup> 1.9 <sup>+</sup> 1.7 <sup>+</sup> 1	.5 <u>+1.2</u> +0.8 +0.5 +0.3 +0.2 +0.1
	*1.5 <sup>+</sup> 0.9	<u>+0.9</u> +1.2 +1.4 +1.6 +2.0 +2.4	*2.6 *2.6 *2.4 *2.0 *1.6 *1	4 <sup>+</sup> 1.1 <sup>+</sup> 0.8 <sup>+</sup> 0.5 <sup>+</sup> 0.3 <sup>+</sup> 0.2 <sup>+</sup> 0.1
	+0.3 +0.6	*0.9 *1.2 \rightarrow 1.4 *1.6 *2.0 *2.7	*3.3 * <del>3.3 *2.6</del> *2.0 *1.5 *1	.4 <sup>+</sup> 1.1 <sup>+</sup> 0.7 <sup>+</sup> 0.5 <sup>+</sup> 0.3 <sup>+</sup> 0.1 <sup>+</sup> 0.1
	<sup>+</sup> 0.2 <sup>+</sup> 0.5	+0.8 +1.2 +1.6 +1.9 +2.1 +2.4	*3.0 *2.9 *2.4 *2.1 *1.9 *1	5 *1.2 *0.7 *0.4 *0.2 *0.1 *0.1
			S <sup>2</sup>	.0 +1.8 +0.8 +0.4 +0.2 +0.1 +0.1
		<u>/</u>		.1 *1.8 *0.9 *0.4 *0.2 *0.1 *0.1
				.6 <sup>+</sup> 1.2 <sup>+</sup> 0.8 <sup>+</sup> 0.5 <sup>+</sup> 0.3 <sup>+</sup> 0.2 <sup>+</sup> 0.2
+1.1 +1.3 +0.9 +0.4 +0.2 +0.1 <u>+0.1</u> +0.2 +0.3 +0.7 +1.0 +1.1 +1.3 +1.5 +0.8				4 <sup>+</sup> 1.2 <sup>+</sup> 0.9 <sup>+</sup> 0.7 <sup>+</sup> 0.5 <sup>+</sup> 0.3 <sup>+</sup> 0.2
$\begin{array}{c ccccccccccccccccccccccccccccccccccc$	<u>+1.6</u> +1.6 +2.6 +3.9 +4.4	<b>c S c c c c c c c c c c</b>	+1.9 +1.4 +1.4 +1.8 +2.6 +3	$\begin{array}{cccccccccccccccccccccccccccccccccccc$
°5.1 °5.4 °4.5 °2.5 °1.9 °1.5 °1.5 °1.9 °2.3 °3.4 °5.1 *5.5 °4.5 °2.7 °2.2				
°3.6 °3.9 °3.3 °2.1 °1.5 °1.2 °1.1 °1.4 °1.8 °3.1 °3.9 ⁺4.2 °3.7 °2.3 °1.8				
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 $\mathbf{X}$ DRAWING RELEASE LOG • 12.04.18 - PRE-APP MTG. • 01.31.19 - DRAWING RELEASE

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NEW



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