

<u>Utility Legend</u>

existing proposed

sanitary main sanitary service

water main

water service (fire)

natural gas main

overhead electric

fence-chainlink fence-wood

treeline

fence-barbed wire

water service (domestic) water service (irrigation)

natural gas service schematic

underground primary electric

underground secondary electric

underground cable/phone/data

underground cable/phone/data service

storm sewer (existing)

storm sewer (solid wall, proposed) storm sewer (solid wall, proposed)

storm sewer (perforated, proposed)

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____ datu _____ ----- datsu ------

____X____ <u>Symbols</u>

- (\mathbb{S}) sanitary manhole service cleanout oco force main release valve
- rectangular structure circular structure Ο fire hydrant У water valve \otimes^{WV} (M)water meter
- BFP backflow preventer natural gas meter \boxtimes^{g} service transformer (pad mount) T S primary switch gear ₩. light pole С cable/phone/data junction box o—___ street light pedestrian street light 0-⊕ electric pole Ø

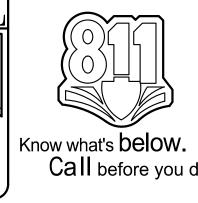
guy wire

end section

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<u>Legal Description:</u> (per Olsson "FINAL PLAT OF CHESTNUT SOUTH")

All of Lots 1, 2, 3, 4 and 5, WILLIAMS AND DEVENPORTS SUBDIVISION and all of Lots 6, 7, 8, 9, 10 and 11, CITY OF OLATHE, both being subdivisions of land and the vacated alleyway by Ordinance dated August 1, 1930 as Document No. 179760 in Misc. Book 17 at Page 394, Ordinance No. 355–C recorded August 27, 1970 as Document No. 860145 in Misc. Book 210 at Page 341 and Ordinance No. 316 recorded December 20, 1974 as Document No. 1004958 in Book 1008 at Page 970, all in the Northeast Quarter of Section 35, Township 13 South, Range 23 East of the 6th Principal Meridian in the City of Olathe, Johnson County, Kansas, being bounded and described as follows: Beginning at the Northeast corner of said Lot 1, said corner being the intersection of South right-of-way line of E Park Street, as now established and the West right-of-way line of Water Street as now established; thence South 02°02'51" Fast along West right—of—way line of Water Street, as now established; thence South 02°02'51" East, along said West right—of—way line of said Water Street, 317.00 feet to the Southeast corner of said Lot 11; thence South 87°56'03" West, along the South line of said Lot 11 and the South line of said Lot 10, 272.50 feet to the Southwest corner of said Lot 10, said corner also being a point on the East right-of-way line of Chestnut Street, as now established; thence North 02°02'51" West, along said East right-of-way line, 317.00 feet to the Northwest corner of said Lot 5, said corner also being a point on the South right-of-way line of said E Park Street; thence North 87°56'03" East, along said South right—of—way line, 272.50 feet to the Point of Beginning. Containing 86,382 square feet or 1.98 acres, more or less.

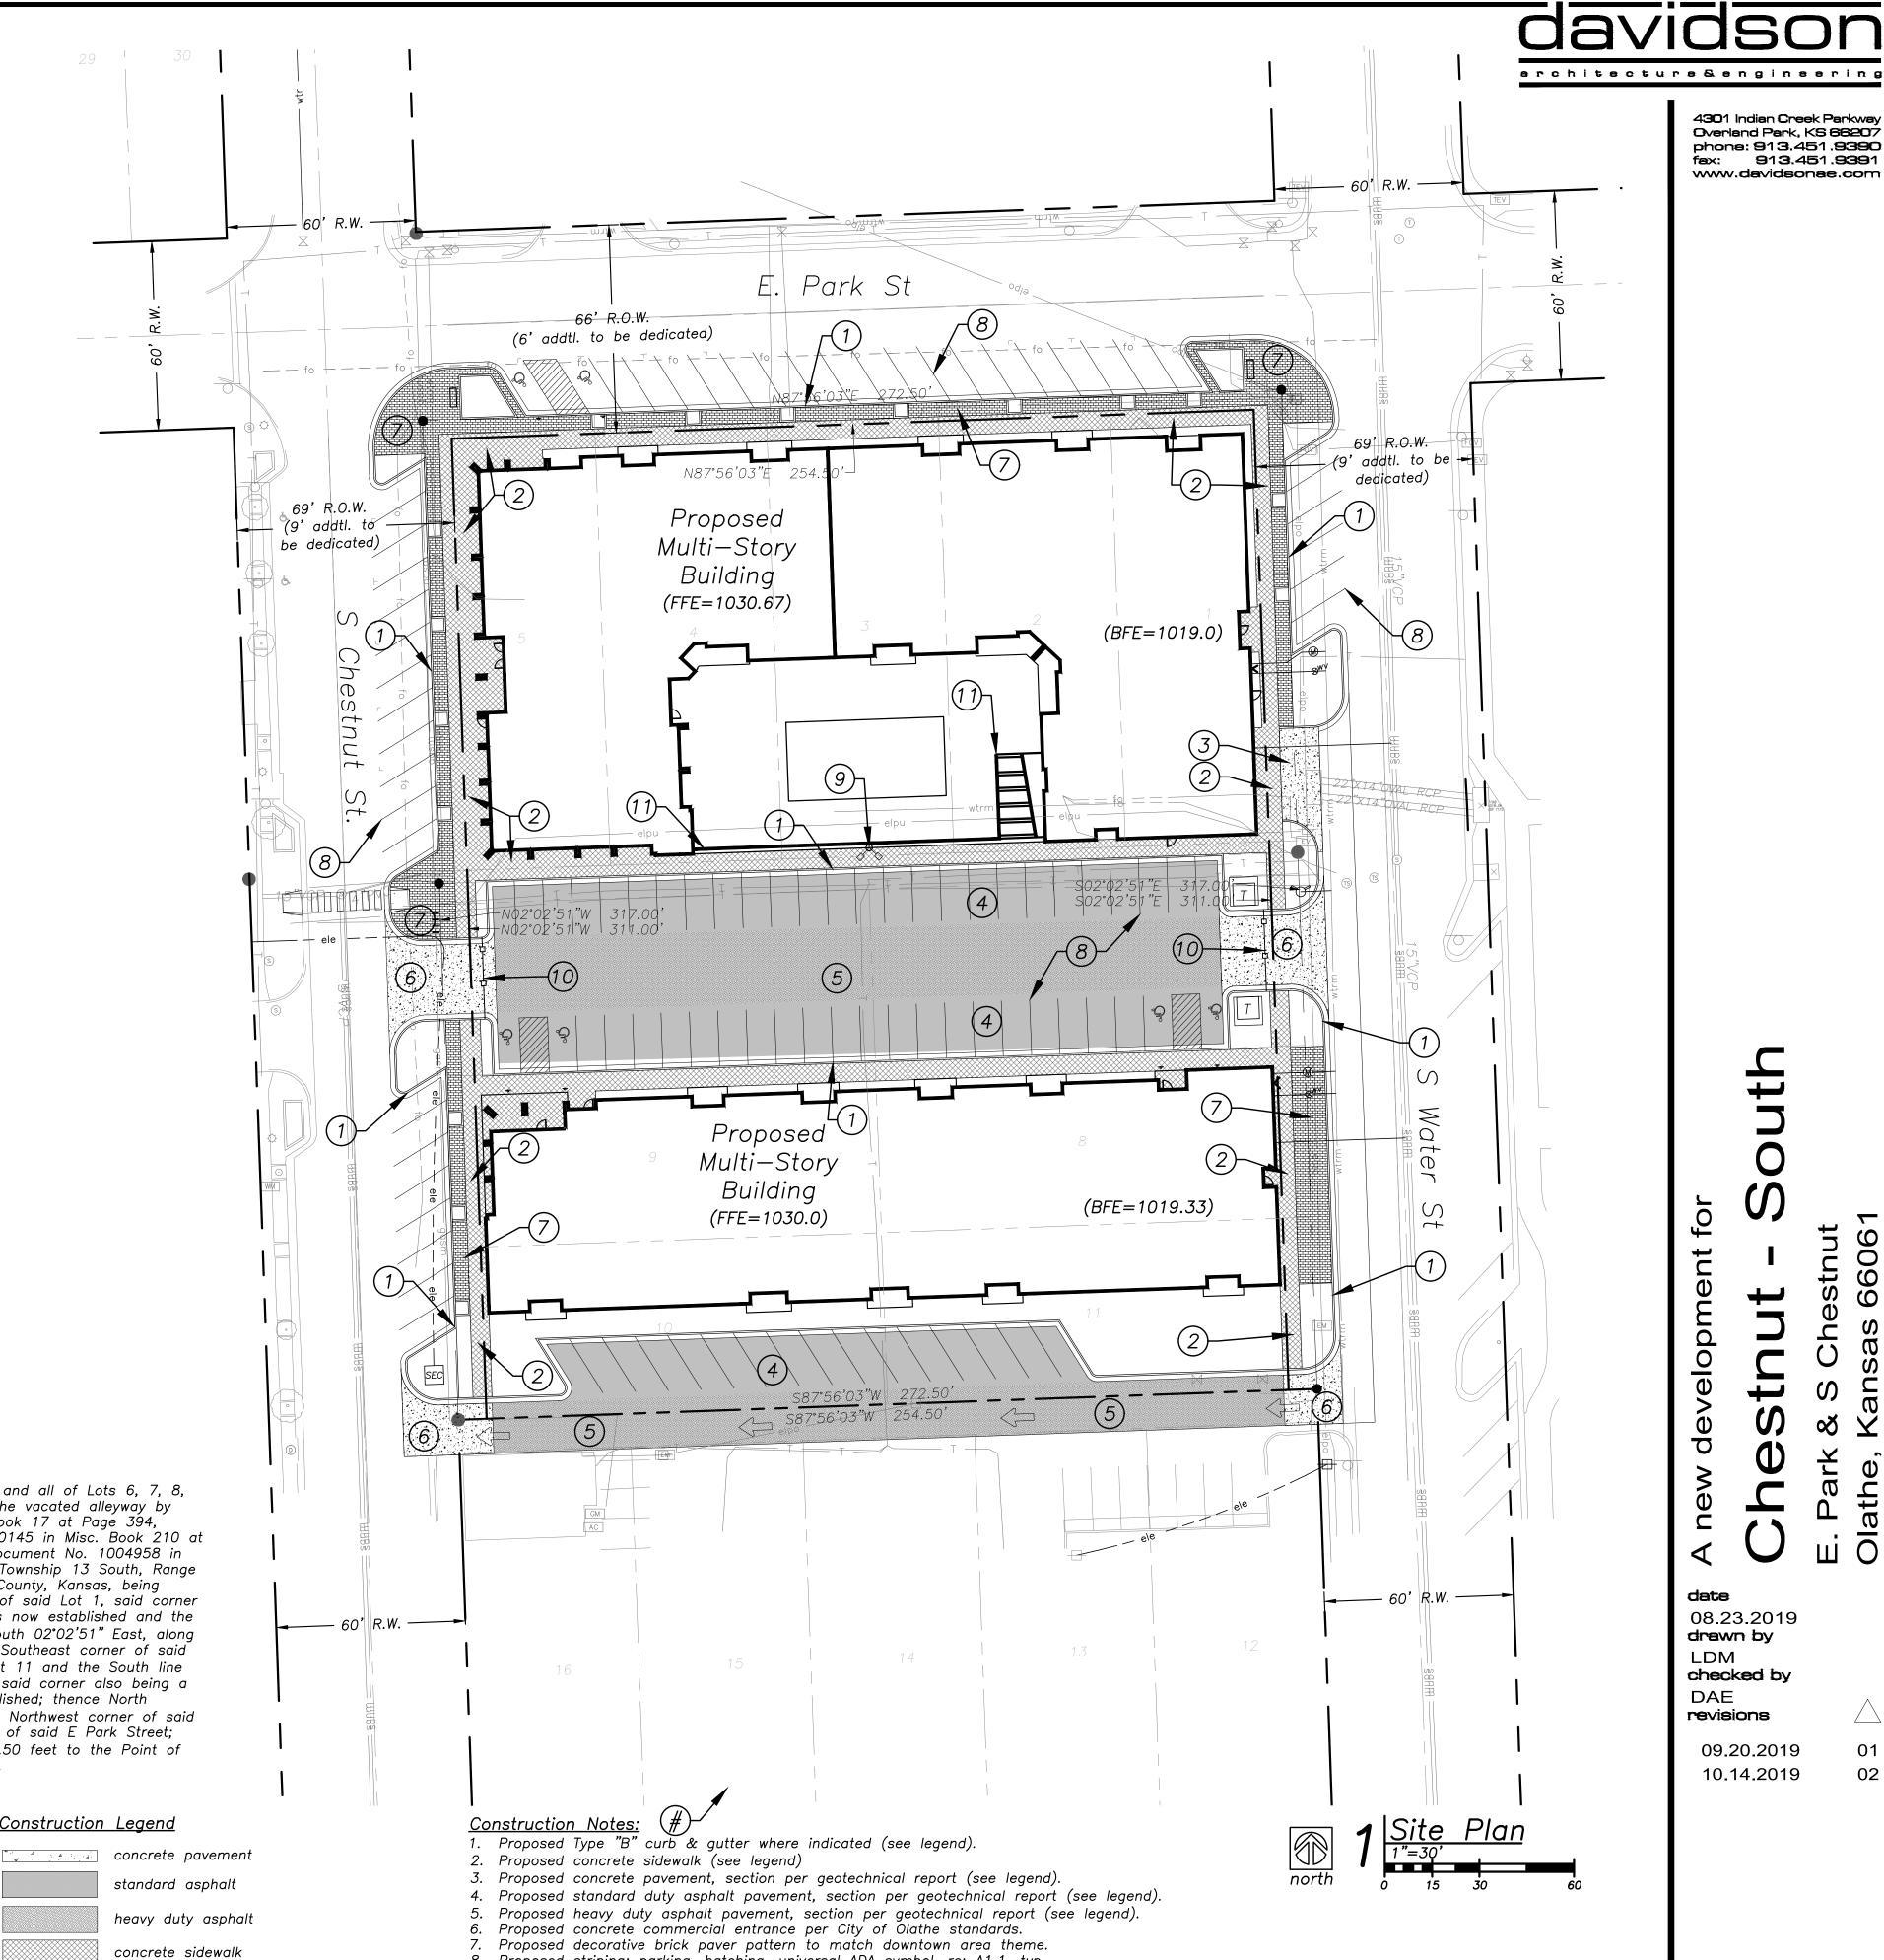
<u>Property Legend</u>

_ _ ----- right of way _____

____ _ _ _ _ _ _ _ _ _ _ _ _ lot lines

____ __ __ __ __ __ easements

Call before you dig.



______ Type "B" curb & gutter

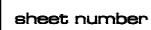
8. Proposed striping: parking, hatching, universal ADA symbol, re: A1.1, typ. 9. Proposed site lighting, re: Arch plans, typ. 10. Proposed access gate, re: Arch plans, typ.

11. Proposed retaining wall at courtyard/pool.

Construction Legend

property lines

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general notes:

- All construction shall conform to the standards and specifications of the city of Olathe, Kansas. • The general contractor shall contact all utility companies prior to the start of construction and verify the location
- and depth of any utilities that may be encountered during construction. The contractor shall field verify existing surface & subsurface ground conditions prior to start of construction
 Slopes shall maintain a maximum 3:1 slope. Refer to Civil Engineering drawings for grading plans.
- The contractor shall be responsible for obtaining all required permits, paying all fees, and otherwise complying
- with all applicable regulations governing the project.
- Place silt fence for erosion control per Civil Engineering drawings and as required.
 Provide a temporary gravel access drive to prevent mud from being deposited onto the adjacent road.
- Prior to installing any structure on a public storm sewer, the contractor shall submit shop drawings for the structure(s). Installation shall not occur until drawings have been approved by public works.
- Prior to installing, constructing, or performing any work on the public storm sewer line (including connecting private drainage to the storm system) contact the city for inspection of the work. contact must be made at least 48 hours prior to the start of work.
- Connections to the public storm sewer between structures will not be permitted.
- All above ground utility termination points shall be screened from view with appropriate landscaping or building elements and shall be prefinished or painted to match the primary adjacent wall color. • Prior to final inspection, the General Contractor shall meet with the Fire Department to designate fire lane and
- fire lane sign locations to be installed per Fire Department direction and requirements. • A Knox Box shall be installed on the building and location shall be coordinated with the Fire Department.

construction notes:

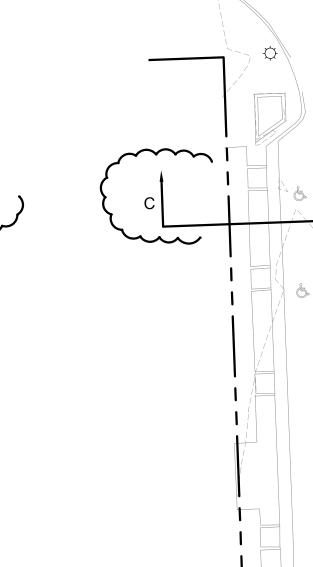
- 1. Furnish and install concrete sidewalk 4" minimum thickness with 6x6 10/10 WWF steel mesh. Control joints at 5'-0" o.c. Broom finish for non-slip surface.
- 2. Not used.
- 3. Furnish and install concrete stoop to frost depth at all exterior door locations, per Structural Engineer. 4. Not used.
- 5. Furnish and install decorative brick paver per City of Olathe standards with pattern and color to match existing. 6. Courtyard landscaping and paver design per Landscape Architect and Hardscape plans to be determined at permit phase. \cdots
- Furnish and install parking lot striping to be painted white with 4" stroke.
 Furnish and install ADA ramp and sidewalk per Civil Engineer.
- Furnish and install ADA parking signage per detail, typ. Mount sign at not more than 60" a.f.g. to bottom. Sign to contain the universal handicap symbol and "VAN ACCESSIBLE" as required per ADA and within 5' of stall.
 Furnish and install ADA striping and universal symbol painted white with 4" stroke.
- 11. Furnish and install new striping and signage at proposed loading zone.
- 12. Not used. 13. Not used.
- 14. Not used.
- 15. Furnish and install new raised concrete curb planter bed with 2'-0" perimeter paver surround per City of Olathe standard with pattern and color to match existing.
- 16. Furnish and install concrete transformer pad at new transformer location per Civil Engineer.
- 17. Not used. 18. Not used.
- 19. Furnish and install new LED parking lot lighting fixtures on non-adjustable head with cut-off lens on prefinished pole and concrete base per MEP Engineer.
- 20. Not used.
- 21. Furnish and install flush, 6" concrete edging and 4' x 4' landscape tree grate per landscape architect.
 22. Furnish and install building mounted LED parking lot lighting fixtures on non-adjustable head with cut-off lens
- per MEP Engineer. 23. Furnish and install prefinished bench as part of site furniture package, to meet City of Olathe specifications. 24. Furnish and install prefinished bicycle rack as part of site furniture package, to meet City of Olathe
- specifications.
- 25. Furnish and install new crosswalk stripping per City of Olathe specifications.
 26. Furnish and install parking lot gates. Operator shall include an opener function that will respond to Emergency Service vehicle audible tone opener and shall include a knox box with fob or opener.

project location

2 Vicinity Plan scale: NTS

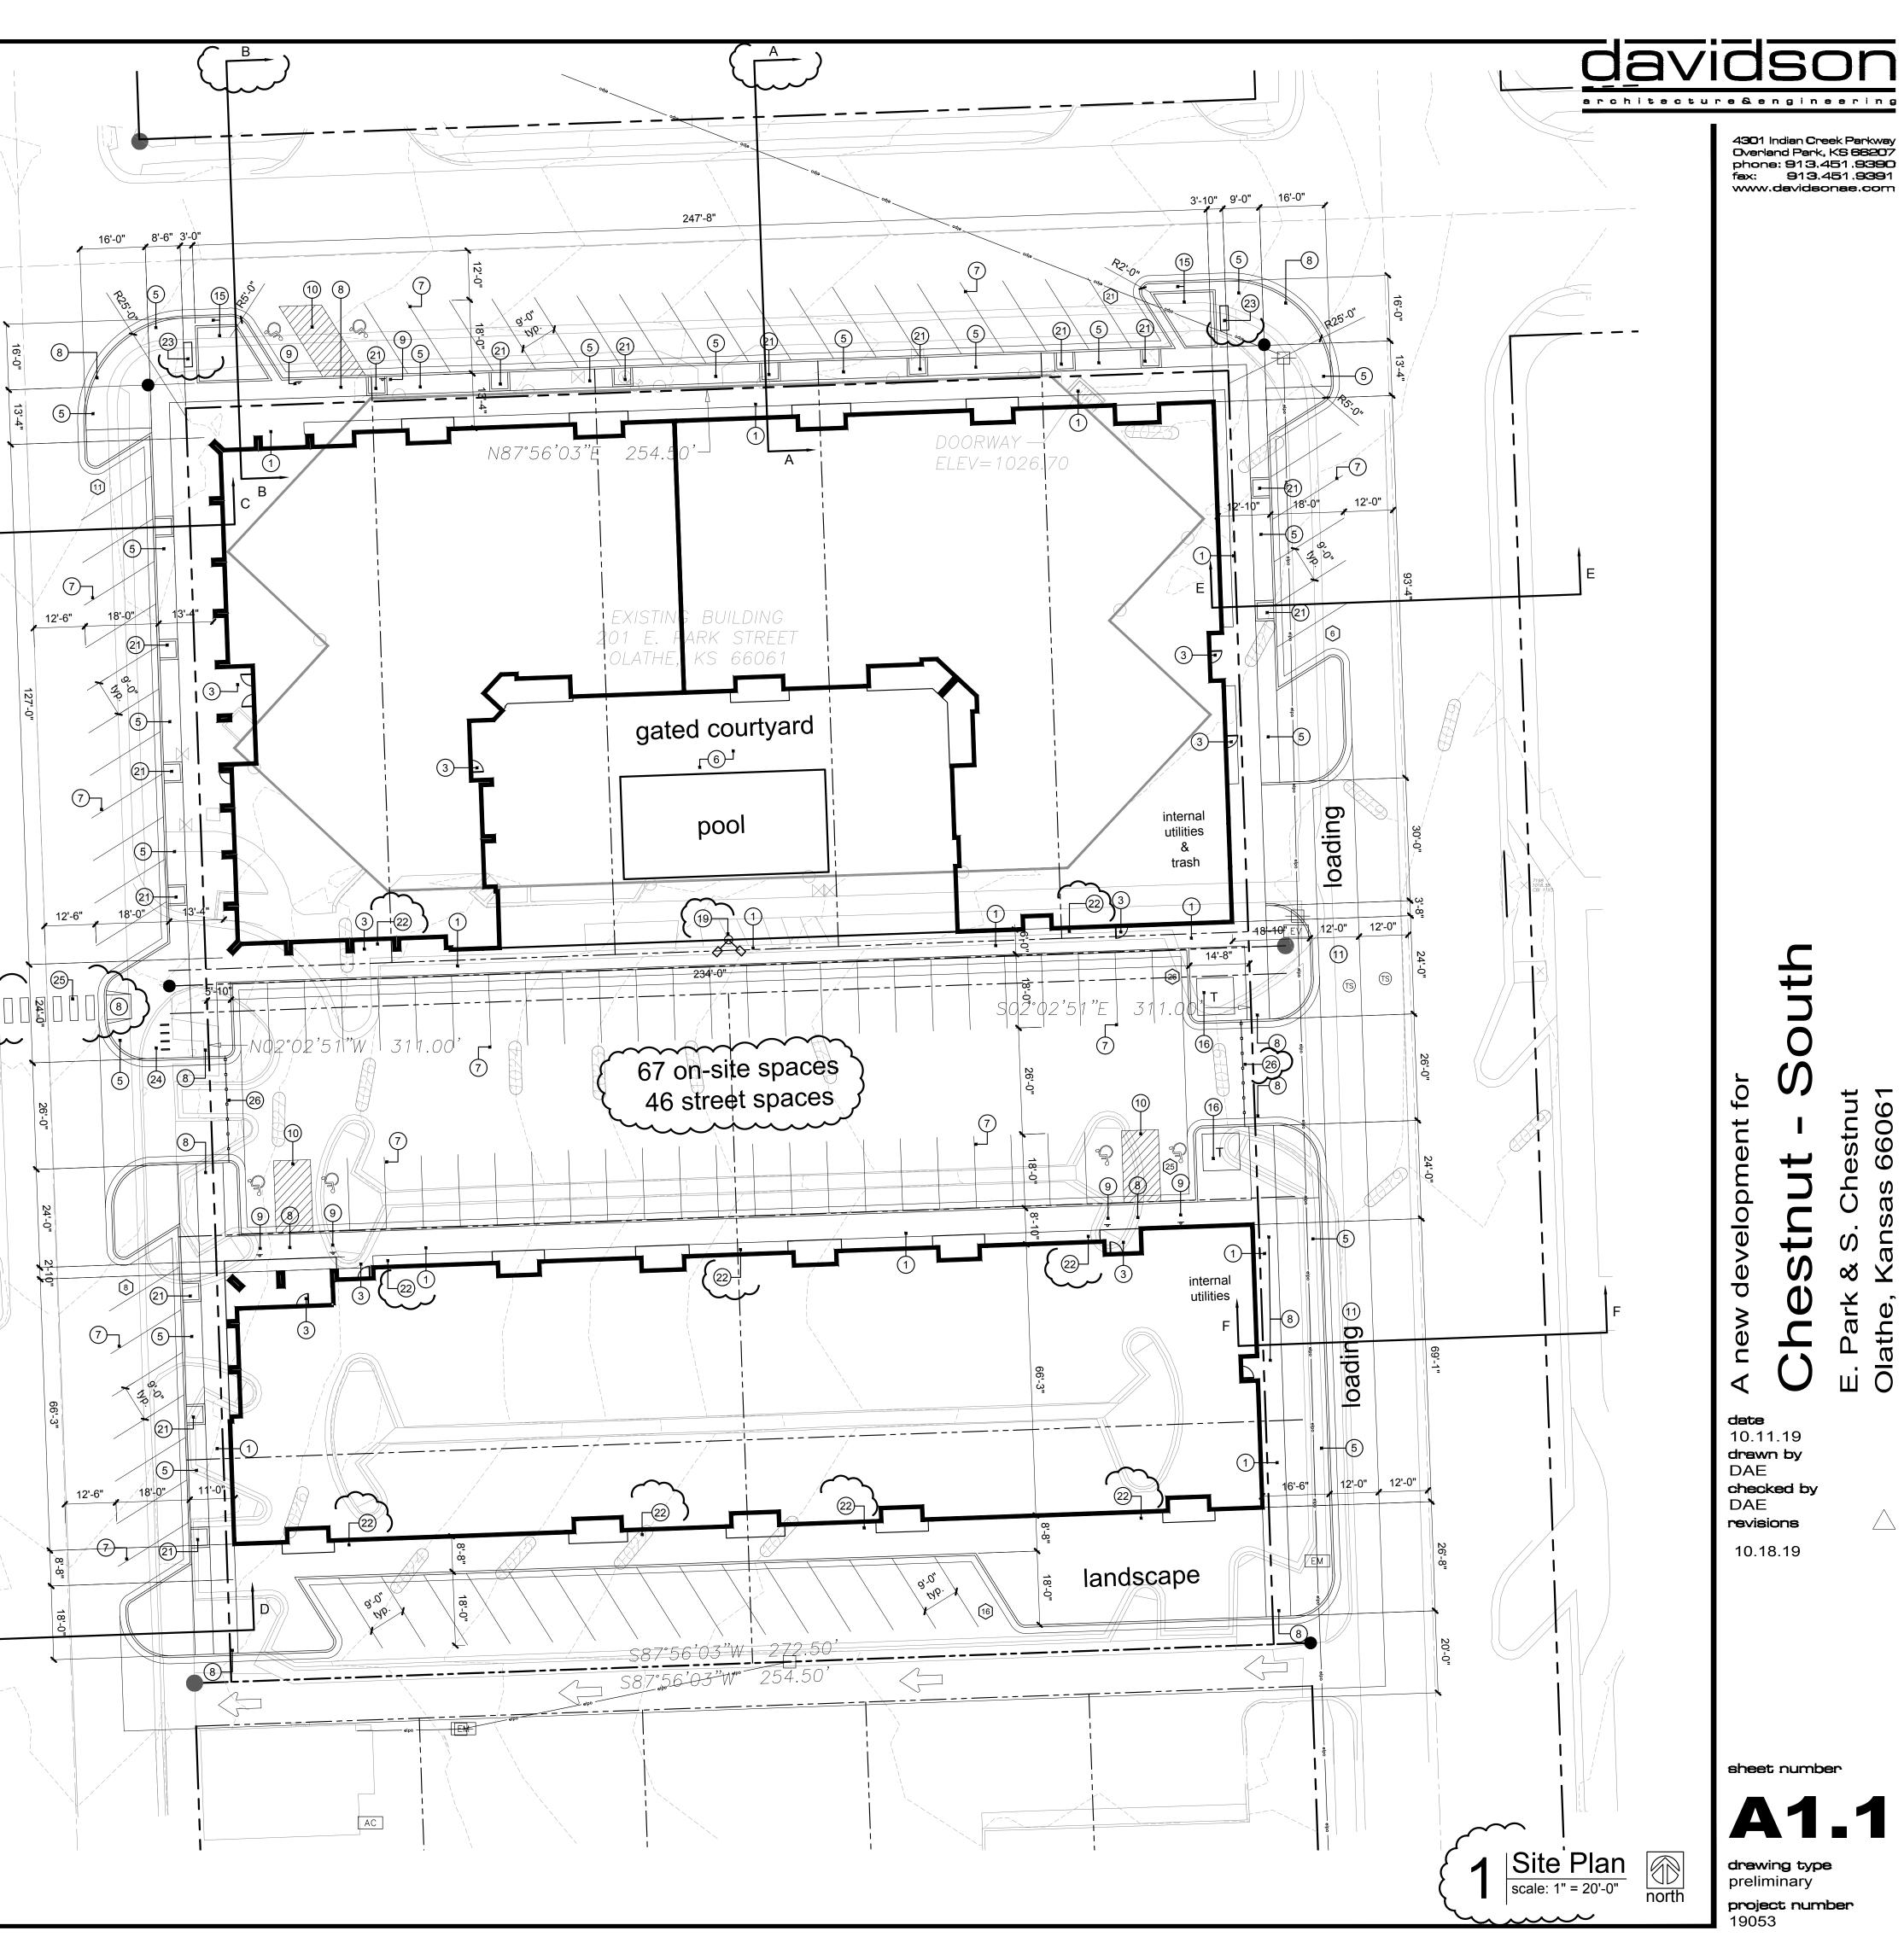


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> 00 Olath

date 10.11.19 **drawn by** DAE **checked by** DAE revisions 10.18.19

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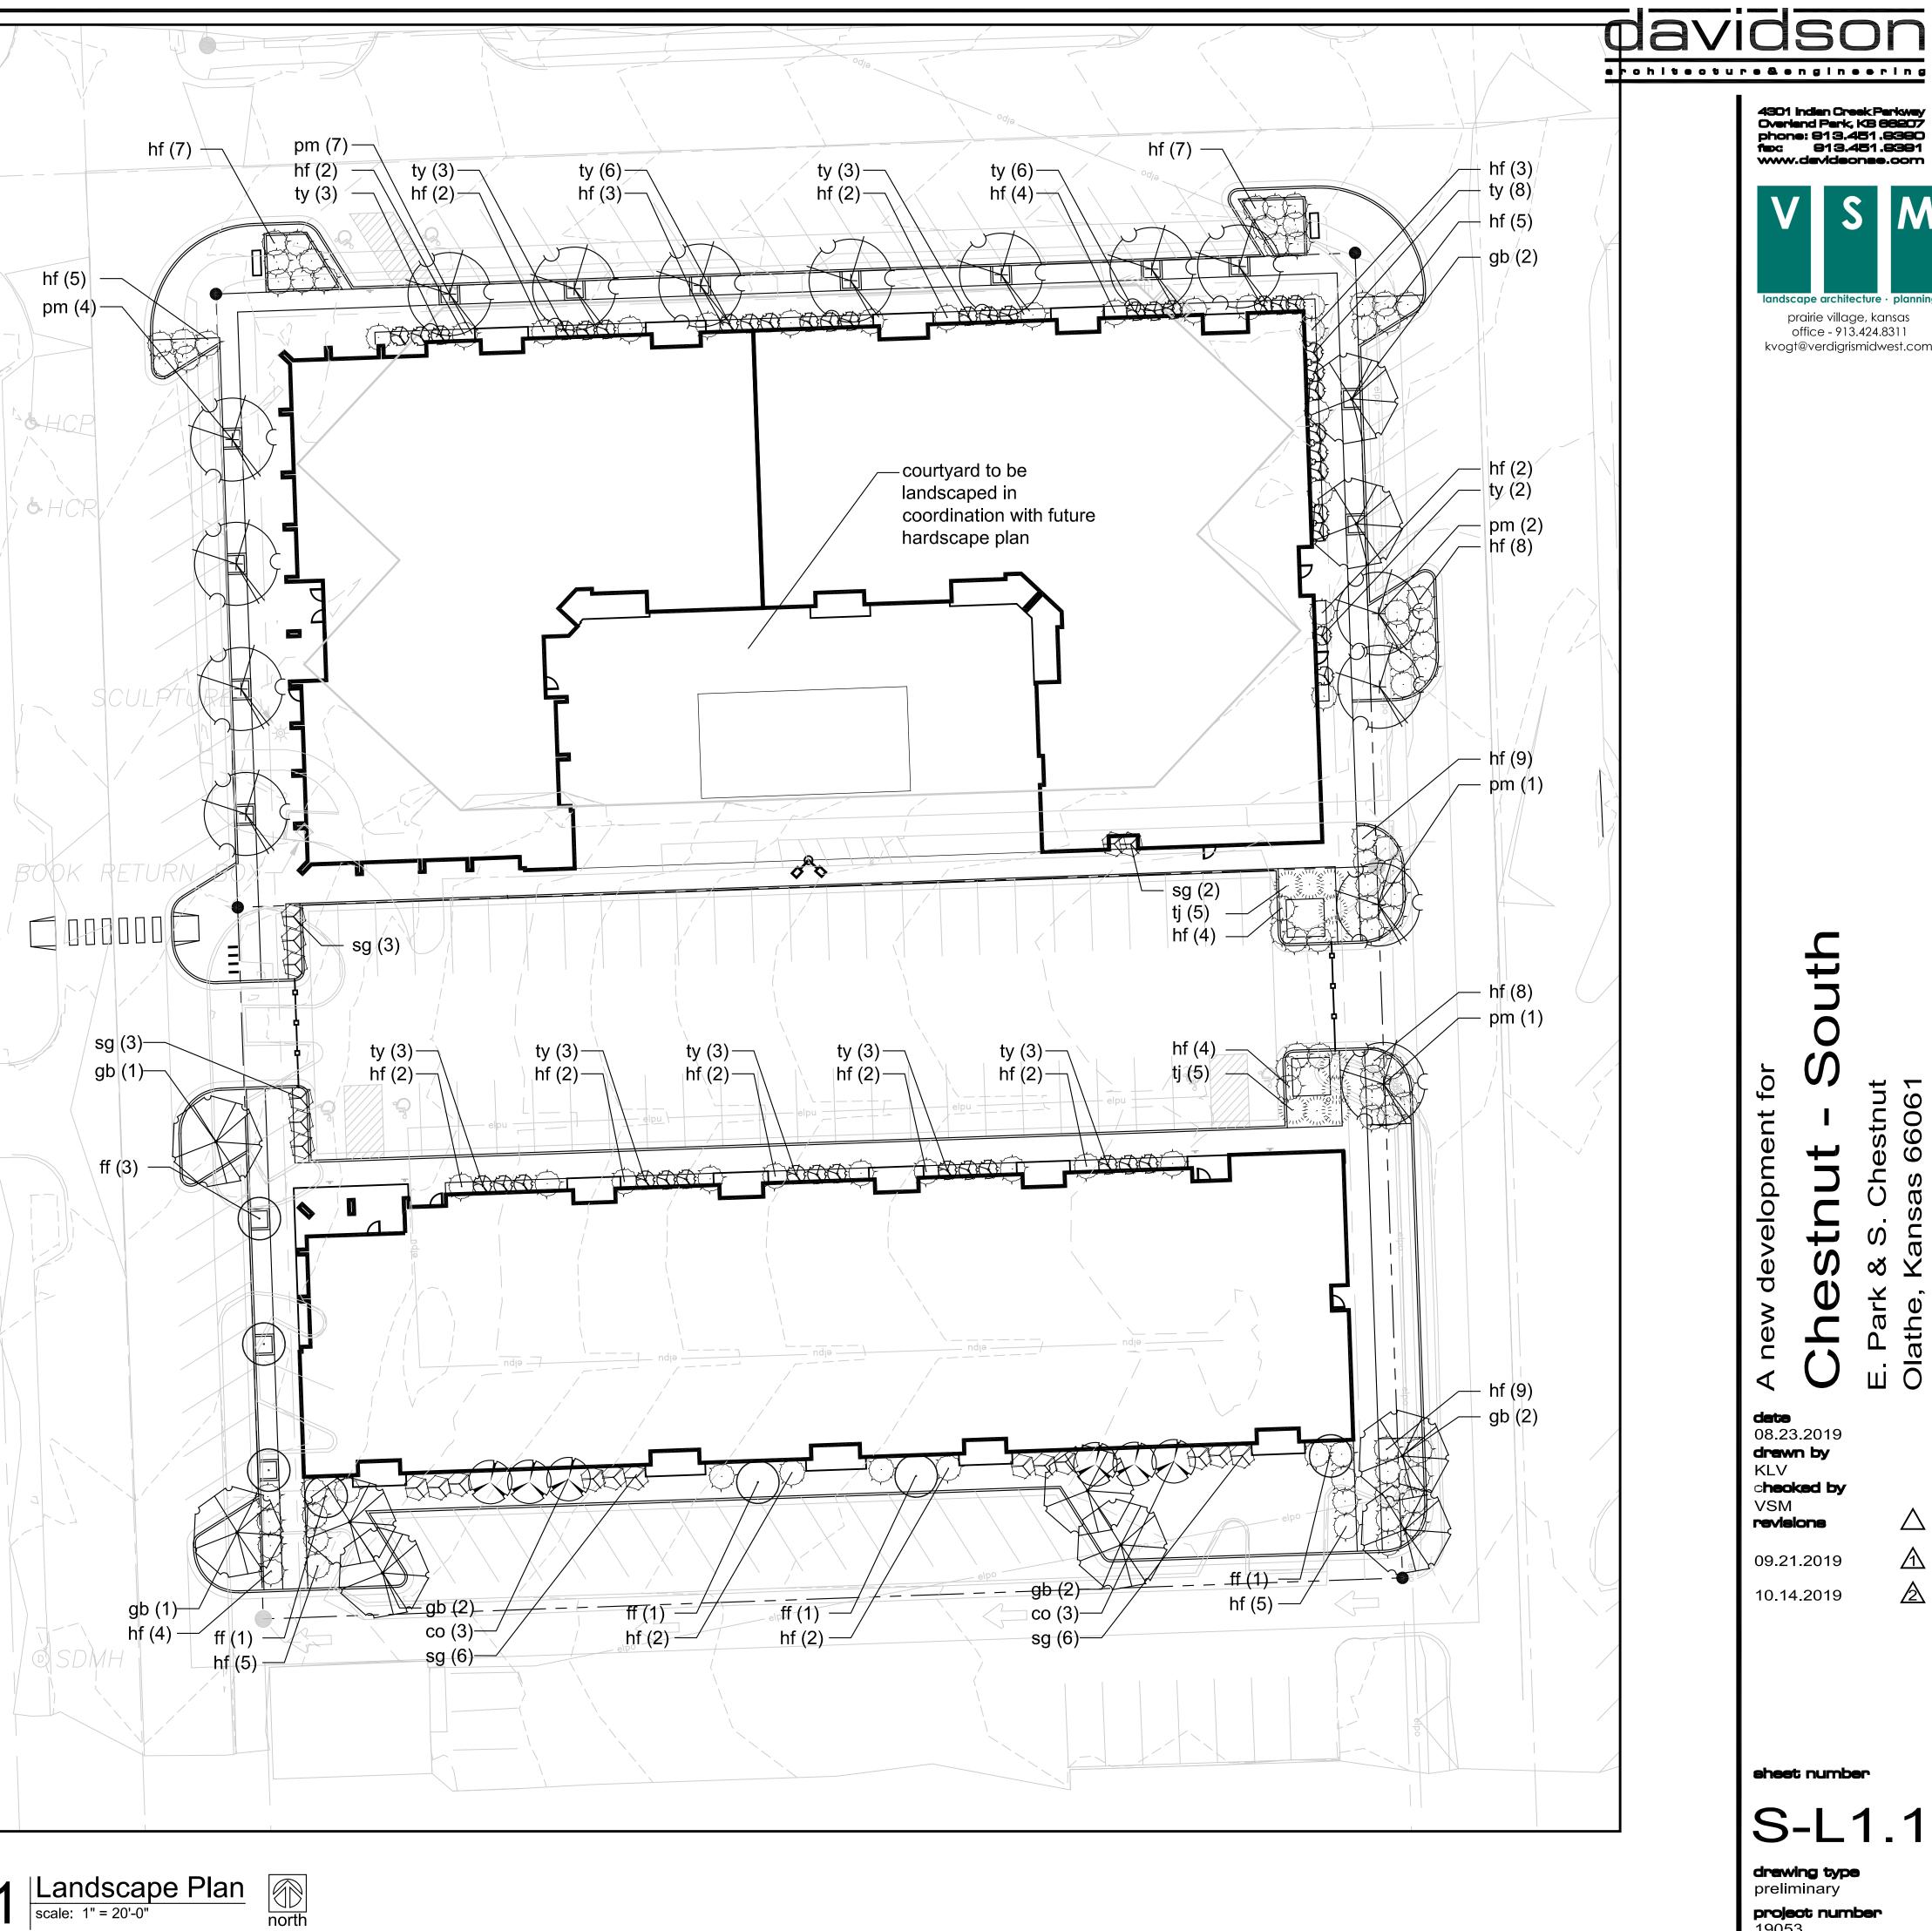
development

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sheet number



1001	key us trees	qty.	botanical name		common name	size	spacing
	gb	10	Ginkgo biloba 'Princeton Sentry'		Princton Sentry Ginkgo	2" cal.	per plan
	pm	15	Acer Griseum		Paperbark Maple	2" cal.	per plan
	СО	6	Quercus x warei 'Long'		Regal Prince Columnar Oak	2" cal.	per plan
	ff	7	Carpinus Betulus 'Frans Fontaine'		Frans Fontaine Hornbeam	2" cal.	per plan
gre	en trees	10	huninamua) (incluiona ITa dari		Taylor Juniper	5' ht.	per plan
	tj si	0	Juniperus Virginiana 'Taylor' Juniperus Chinensis 'Spartan'		Spartan Juniper	5' ht.	per plan
bs a	and grasses	, , , , , , , , , , , , , , , , , , ,					
	fl	0	Rhamnus Frangula		Fine Line Buckthorn	b&b	per plan
	hf	112	Pennisetum Alopecuroides 'Hameln'		Hameln Fountain Grass	3 gal.	per plan
	sg	22	Panicum Virgatum 'Northwind'		Northwind Switch Grass	3 gal.	per plan
	ty	46	Taxus x Media 'Tauntonii' PLY WITH ANSI Z60.1; AMERICAN STANDARD FOR NURS		Taunton's Yew	3 gal.	per plan
3. 5. 5. 7. 9. 0.	SHALL FIEI CONSTRUCT LIMITS OF OTHERWIS BEYOND IS INSTALLAT REFER TO EROSION OF THE CONT PRE-CONS PRIOR TO A PLANT QU/ PREVAIL IF CALCULAT THE CONT STAKING IS THE CONT MULCH AR BEDS TO A TREE LOC/ AND LIGHT LANDSCAF KIND, SIZE AMERICAN MOST REC THE CONT PROBLEMS THE PLAN MATERIAL APPROVEL	LD VERIFY CTION OPE CONSTRUE SENOTED SENOTED SEQUIRE TON AND E CIVIL DRA CONTROL, RACTOR S STRUCTION ALL WORK ANTITIES A CONFLIC TING OWN O RACTOR IS SCOMPLE RACTOR S SCOMPLE RACTOR S COUND ALL ATIONS IN FIXTURES PE ARCHITE AND QUAL STANDAR ENT EDITIO RACTOR S STO THE L IS SUBJEC AVAILABIL D BY THE O	CTION ARE THE PROPERTY LINES, UNLESS ON THE PLANS, EXCEPT WHERE ACCESS D FOR CONSTRUCTION RELATED TO UTILITY EQUIPMENT ACCESS TO THE SITE. WINGS FOR ALL GRADING AND BERMING, STORM DRAINAGE, UTILITIES AND SITE LAYOUT. HALL ARRANGE AND CONDUCT A I MEETING ONSITE WITH LANDSCAPE ARCHITECT ARE FOR INFORMATION ONLY. DRAWING SHALL TOCCURS. CONTRACTOR IS RESPONSIBLE FOR QUANTITIES AND BID ACCORDINGLY. S TO NOTIFY LANDSCAPE ARCHITECT AFTER TED AND BEFORE PLANT PITS ARE EXCAVATED. HALL PLACE SHREDDED HARDWOOD BARK TREES TO A DEPTH OF 3", AND IN ALL PLANTING 5 2". WALNUT PRODUCTS ARE PROHIBITED. AREAS ADJACENT TO DRIVES, WALKS, WALLS S MAY BE FIELD ADJUSTED AS APPROVED BY THE ECT.	23. 35.	COMPOSTED ORGANIC SOIL INTO EX PERENNIAL AND ANNUAL PLANTING E 6". THOROUGHLY MIX ORGANIC MAT BY ROTOTILLING OR OTHER APPROV DEPTH OF 12". APPLY A COMMERCIAL ROOT STIMUL LANDSCAPE ARCHITECT PRIOR TO U GROUND COVERS AT RATES RECOM DURING FIRST PLANT WATERING FOL ALL LANDSCAPE AREAS SHALL BE IR EFFICIENCY AUTOMATIC IRRIGATION EVEN COVERAGE OF ALL LANDSCAPI SHALL BE DESIGN-BUILD TO MEET AL IN THE EVENT OF WORK IN OR ON TH TREES OR PLANTINGS PLACED WITH BE REMOVED WITHOUT REPLACEMENT THERE-OF AND SHALL BE REPLACED REQUIRED BY THE CITY. LANDSCAPE ADJACENT TO THE FIRE AND FIRE HYDRANT SHALL ALLOW FO AND ACCESS, WITH NO SHRUBS OR THE FIRE DEPARTMENT CONNECTION	BEDS AT A MINIMUM DE ERIAL INTO THE EXISTI ED METHOD TO A MININ ATOR (APPROVED BY SE) TO ALL SHRUBS AN MENDED BY MANUFACT LOWING INSTALLATION RIGATED WITH A HIGH SYSTEM ACHIEVING 10 E AREAS. IRRIGATION S L CITY REQUIREMENTS E JCW SANITARY MAIN, IN THE SEWER EASEMENT OR COMPENSATION BY THE PROPERTY OW DEPARTMENT CONNECT OR UNOBSTRUCTED VIS IREES WITH IN A 3' RAD	PTH OF NG SOIL MUM ID TURER N. 00% SYSTEM S. SYSTEM S. NT MAY VNER AS STION SIBILITY
3.	SHALL BE (15) OR FAL	OF TREES COMMENC L (SEPTEM	, SHRUBS, SODDED AND SEEDED TURFGRASS ED DURING EITHER THE SPRING (APRIL 15-JUNE 1BER 1-NOVEMBER 15) PLANTING SEASON AND BLE FOR IRRIGATION PURPOSES.				
4.	STEEL EDO SODDED A		E USED ON ALL LANDSCAPE BEDS ABUTTING				
5.	ALL PLANT SYSTEM IS HAS TAKEN	MATERIAI FULLY FUN PLACE.	ACTOR IS TO BE RESPONSIBLE FOR WATERING LS UNTIL THE TIME THE PERMANENT IRRIGATION NCTIONAL AND ACCEPTANCE OF THE PROJECT ANY MATERIAL WHICH DIES, DEFOLIATES (PRIOR THE WORK) WILL BE PROMPTLY REMOVED AND				
6.	SOURCES PERENNIA	, QUANTIT LS, ORNA	SHALL SHOW PROOF OF PROCUREMENT, TES AND VARIETIES FOR ALL SHRUBS, MENTAL GRASSES AND ANNUALS WITHIN 21 THE AWARD OF THE CONTRACT.				
7.	SHALL BE GROWN, S DISEASE A NORMAL F EXCEEDIN	REJECTE SOUND, HE AND INJUF FOR THE S IG SIZES I TOR SHAL	E CALLIPERED AND UNDERSIZED TREES D. ALL PLANT MATERIAL SHALL BE NURSERY EALTHY, VIGOROUS AND FREE FROM INSECTS, RIES, WITH HABIT OF GROWTH THAT IS SPECIES. SIZES SHALL BE EQUAL TO OR NDICATED ON THE PLANT LIST. THE LL SUPPLY PLANTS IN QUANTITY AS SHOWN				
8.	DRAWING	S OR AS D	LL PLANTS IN FIELD AS INDICATED ON THE IRECTED BY THE LANDSCAPE ARCHITECT FOR OWNER PRIOR TO PLANTING.				
9.	OTHERWIS BEDS SHA	SE COVER	EAS, INCLUDING RIGHTS OF WAY, NOT RED BY BUILDING, PAVEMENT AND LANDSCAPE DDED WITH TURF TYPE TALL FESCUE AND OTHERWISE INDICATED BY THE OWNER.				
	INCLUDING	G BUT NO ^T ETER BAN	UND OR BUILDING MOUNTED EQUIPMENT, T LIMITED TO MECHANICAL EQUIPMENT AND IKS SHALL BE SCREENED FROM PUBLIC VIEW IE UDO.				



4301 Indian Creek Parkway Overland Park, KB 68207 phone: 813.451.8380 fax: 813.451.8381 www.davideonae.oom S M ndscape architecture · planning prairie village, kansas office - 913.424.8311 kvogt@verdigrismidwest.com S development for k & S. Chestnut , Kansas 66061 ut tn S E. Park Olathe, Φ A new $\dot{\mathbf{O}}$ **dete** 08.23.2019 **drewn by** KLV c**heoked by** VSM \triangle **revisions** Λ 09.21.2019 \triangle 10.14.2019

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project number 19053





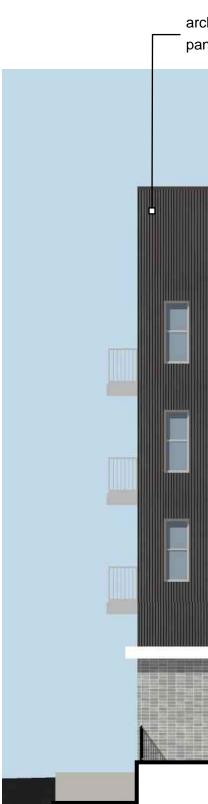
-S. Water Street \longrightarrow

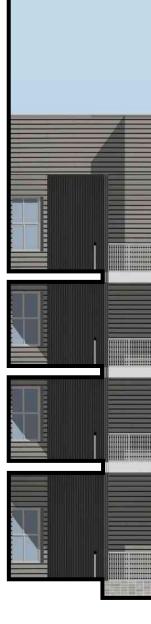
-S. Chestnut Street →

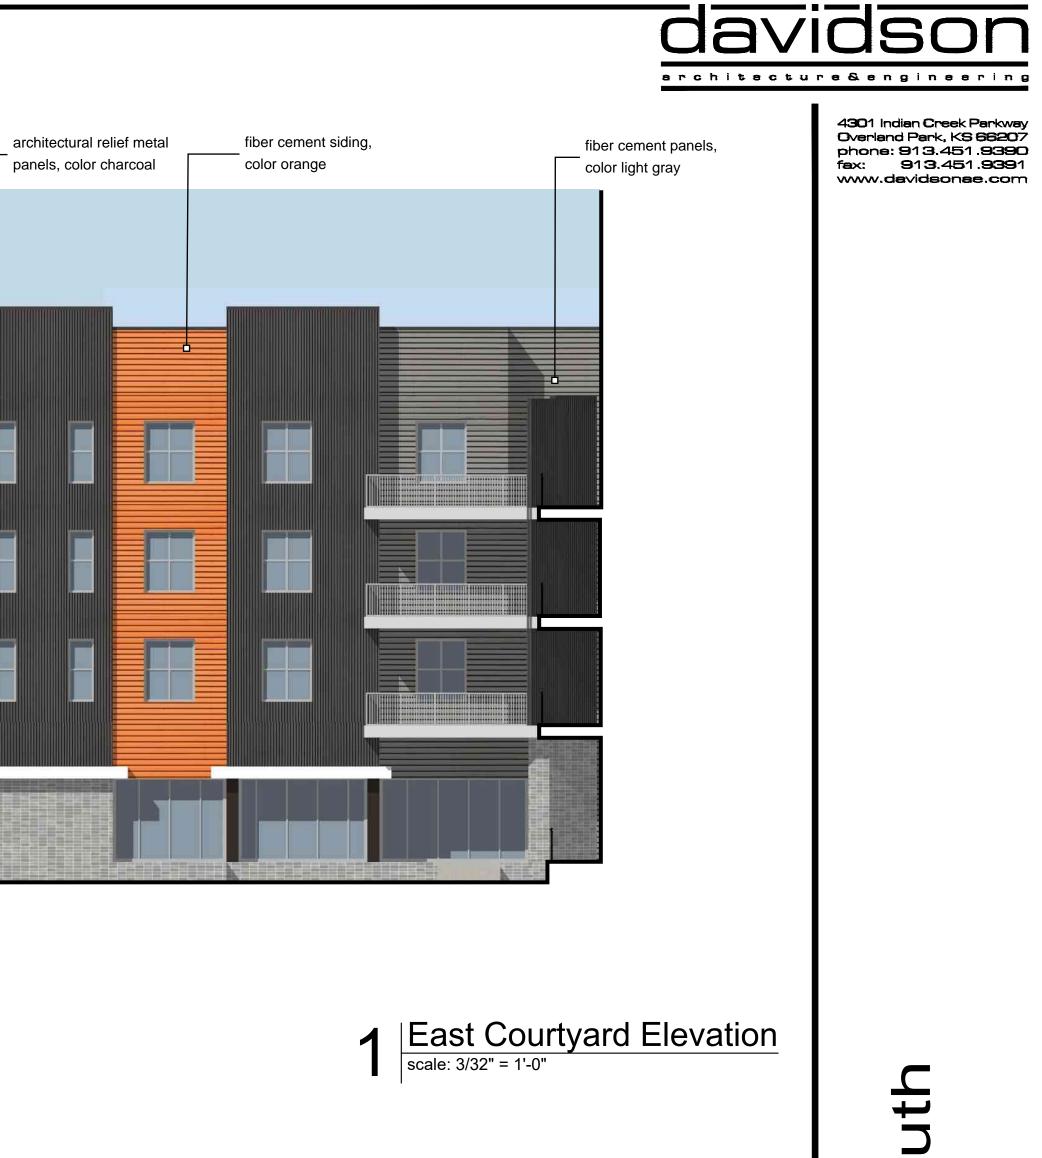
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2 West Courtyard Elevation scale: 3/32" = 1'-0"



Kansas

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date 10.21.2019 drawn by DAE checked by DAE revisions

sheet number







└── overhang

----- brick, color tan-gray

reference landscaping for plantings

2 North Courtyard Elevation













2 Southeast Corner Perspective



4 Northeast Corner Perspective



6 Southwest Corner Courtyard Perspective





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3 Southwest Corner Perspective

5 South Building Entry Perspective

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